

# REGIONAL DISTRICT OF FRASER - FORT GEORGE DORE RIVER - BANK EROSION PROTECTION CONTRACT # CS-24-02 MCBRIDE, BC

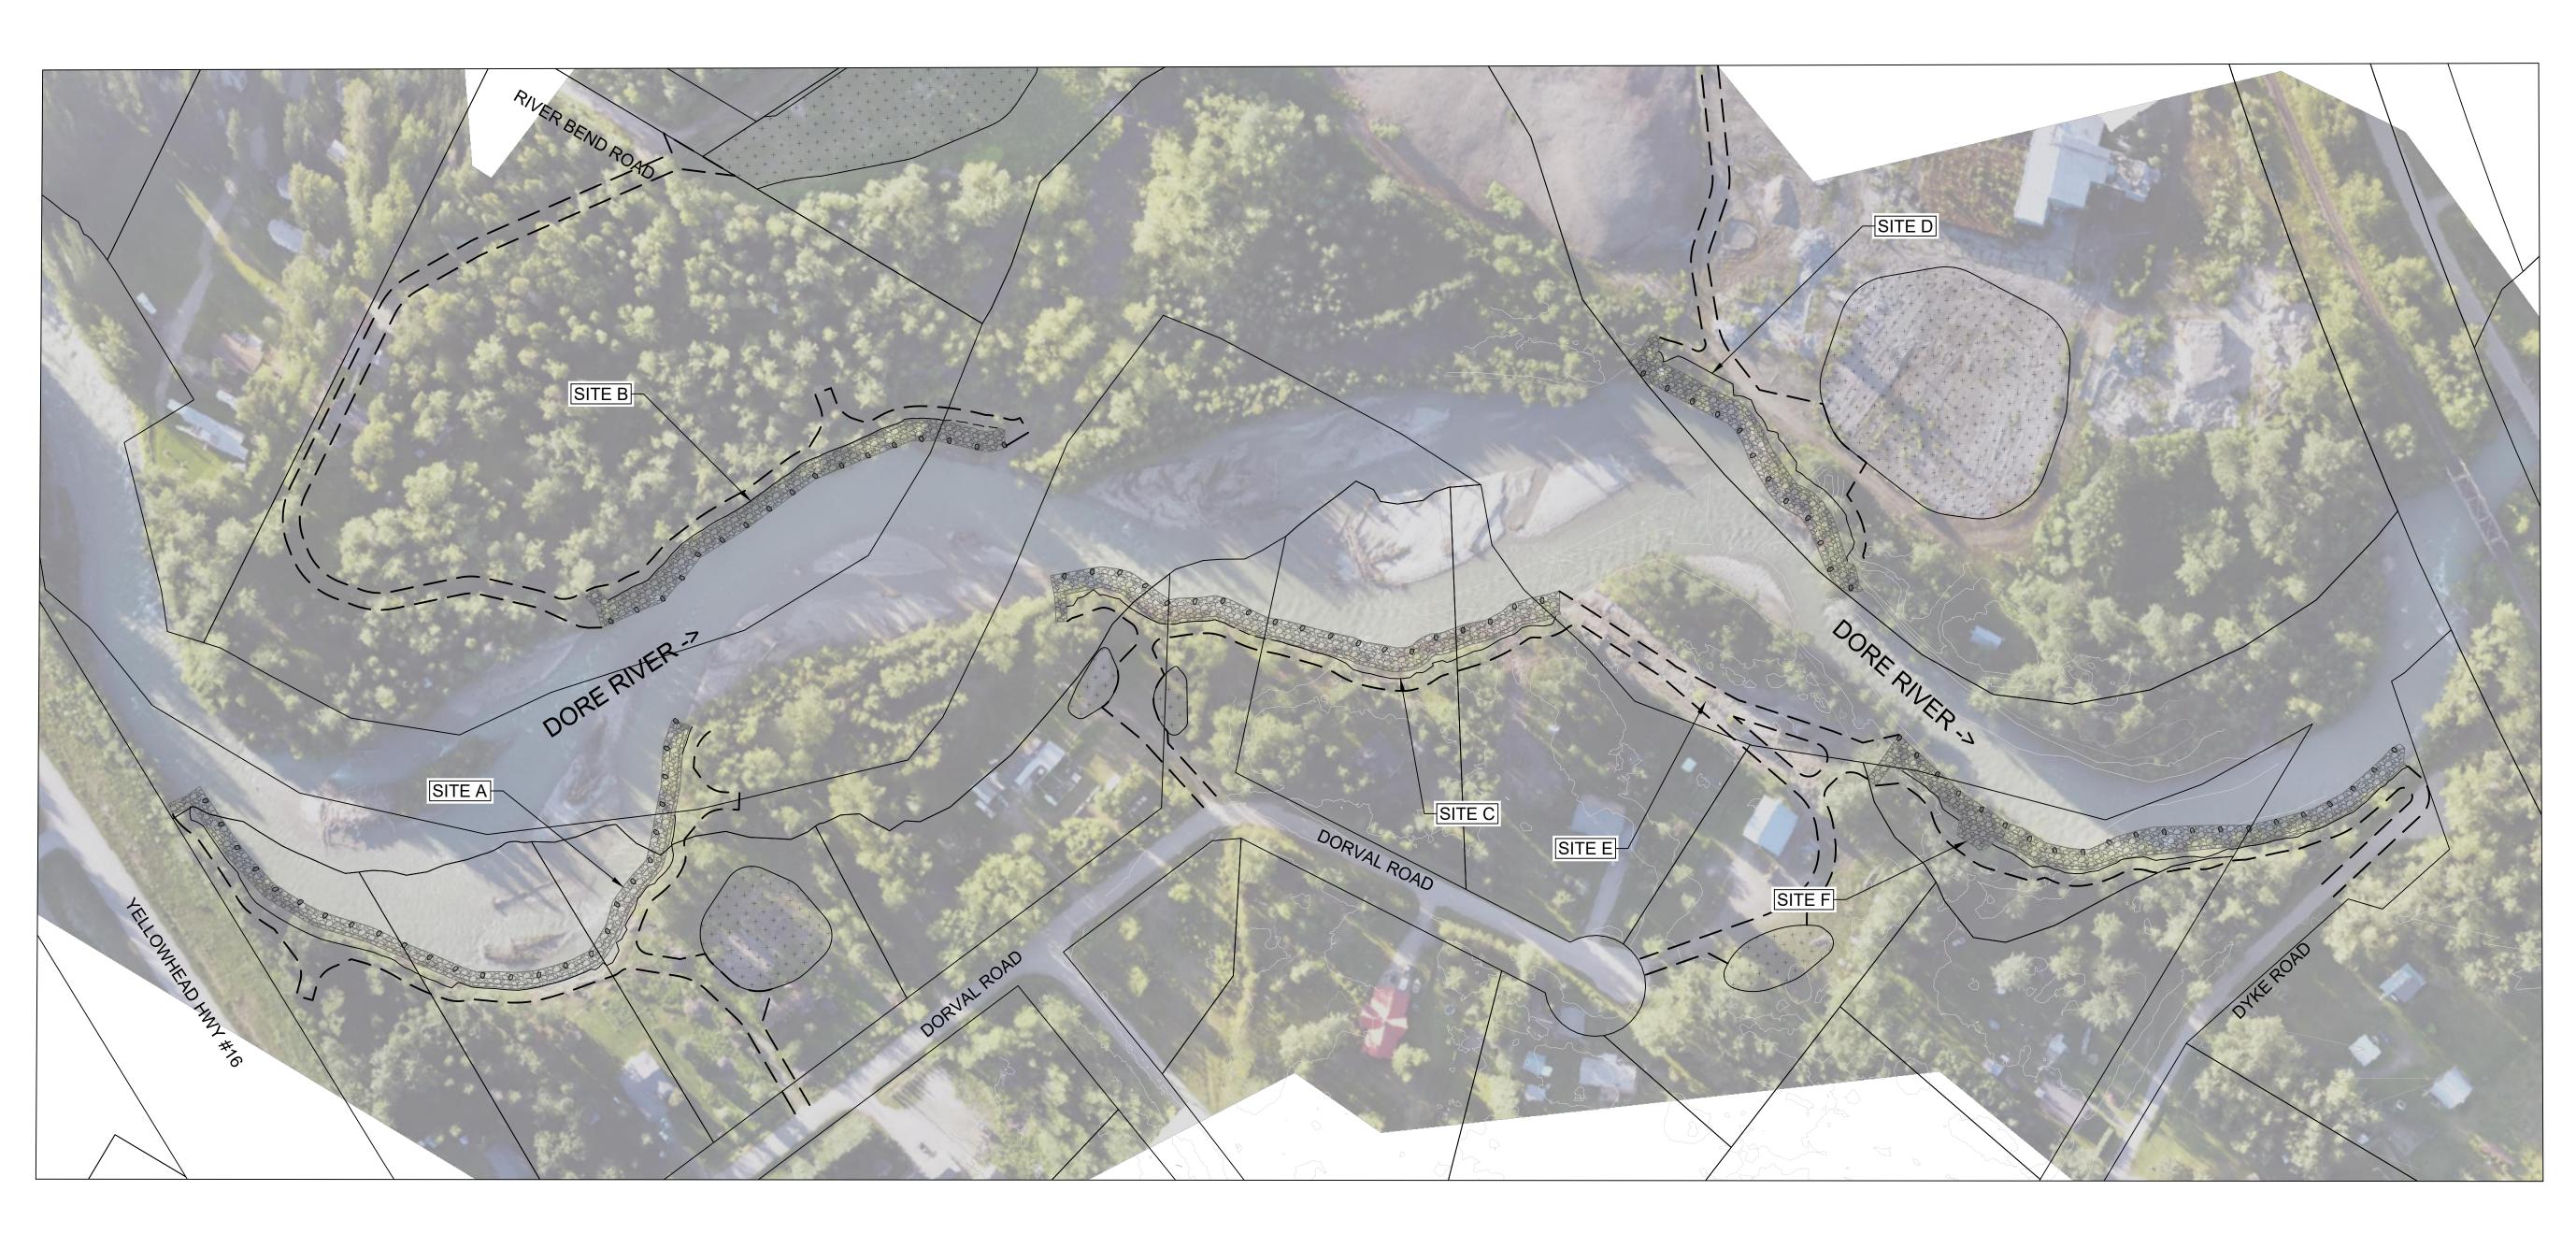

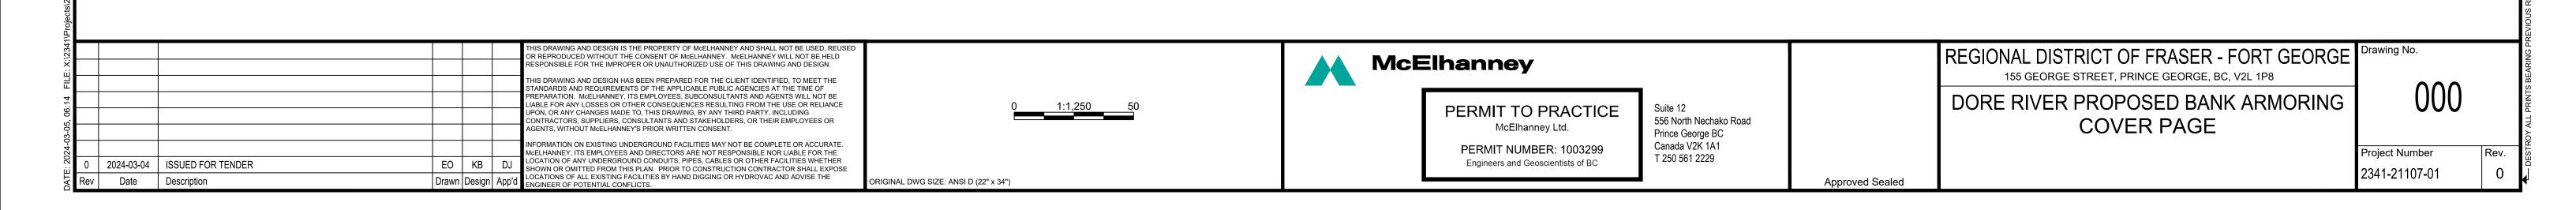

# HYDROTECHNICAL DESIGN PARAMETERS

1.1. Q200 DESIGN FLOW:

186 m³/s

### GENERAL INSTRUCTIONS TO CONTRACTOR

- THE LOCATION AND SIZE OF EXISTING UTILITIES AND SERVICES, AS SHOWN ON THE DRAWINGS IS APPROXIMATE ONLY. PRIOR TO COMMENCEMENT OF CONSTRUCTION THE CONTRACTOR SHALL EXPOSE AND VERIFY THE EXACT LOCATION AND SIZE OF THESE INSTALLATIONS AND SHALL NOTIFY THE CONTRACT ADMINISTRATOR OF ANY DISCREPANCIES, CONFLICTS OR OMISSIONS.
- THE CONTRACTOR SHALL EXERCISE EXTREME CAUTION WHEN WORKING NEAR EXISTING UTILITIES AND SERVICES. ANY DAMAGES SUFFERED BY THESE UTILITIES WHICH MAY BE ATTRIBUTED TO THE CONTRACTORS OPERATIONS, SHALL BE REPAIRED BY THE CONTRACTOR AT THEIR EXPENSE AND TO THE SATISFACTION OF THE AUTHORITY HAVING JURISDICTION.
- WHEN WORKING ON EXISTING PAVEMENT WHICH WILL BE RETAINED FOR FUTURE USE, THE CONTRACTOR SHALL EXERCISE CARE NOT TO CAUSE ANY DAMAGE. ANY DAMAGE CAUSED BY THE CONTRACTOR SHALL BE RETURNED TO EQUIVALENT CONDITION TO THAT EXISTING PREVIOUS AT THEIR EXPENSE AND TO THE SATISFACTION OF THE CONTRACT ADMINISTRATOR.
- 2.4. THE CONTRACTOR SHALL USE ONLY NEW AND APPROVED MATERIALS AND SHALL NOT SUBSTITUTE ANY MATERIALS WITHOUT THE PRIOR WRITTEN APPROVAL OF THE CONTRACT ADMINISTRATOR.
- ALL SURVEY MONUMENTS, PROPERTY PINS, AND PROJECT PRIMARY SURVEY CONTROL PINS, SHALL BE PROTECTED DURING ALL STAGES OF CONSTRUCTION. ANY DAMAGE SUFFERED BY THE MONUMENTS OR PINS SHALL BE REPAIRED BY THE CONTRACTOR AT HIS EXPENSE.
- EXISTING PARKING AREAS, ON-SITE AND OFF-SITE ROADS MUST BE KEPT CLEAN. STREET, ROAD AND PARKING AREA CLEANING SHALL BE DONE BY THE CONTRACTOR AT HIS EXPENSE.
- 2.7. DISTURBANCE TO EXISTING LANDSCAPING OR SURFACE IMPROVEMENT, ATTRIBUTABLE TO THE CONTRACTOR'S OPERATION SHALL BE CORRECTED BY THE CONTRACTOR AT HIS EXPENSE. SUCH REPAIR SHALL BE CARRIED OUT TO THE SATISFACTION OF THE CONTRACT ADMINISTRATOR.
- 2.8. THE CONTRACTOR SHALL NOT ENTER UPON ADJACENT PROPERTIES DURING THE COURSE OF CONSTRUCTION WITHOUT THE PRIOR APPROVAL OF THE PROPERTY OWNER. IF THE CONTRACTOR DOES CAUSE DAMAGE TO ADJOINING PROPERTY THEY SHALL IMMEDIATELY REPAIR IT TO THE SATISFACTION OF THE OWNER. THEY SHALL OBTAIN A LETTER OF CLEARANCE FROM THE OWNER AND SUBMIT IT TO THE CONSULTANT. SUBSTANTIAL COMPLETION SHALL NOT BE GRANTED UNTIL ALL SUCH LETTERS HAVE BEEN RECEIVED BY THE CONSULTANT.

THE OWNER HAS SECURED CONSENT FROM ALL LAND OWNERS ON WHICH WORKS ARE PLANNED FOR CONTRACTOR ACCESS AND MATERIAL LAYDOWN. REFER TO SHEET 102 FOR DETAILS. IF ADDITIONAL AREAS OF PRIVATE LAND ARE REQUIRED TO BE DISTURBED DURING CONSTRUCTION THE CONTRACTOR SHALL COORDINATE WITH THE LAND OWNERS AS REQUIRED AND INFORM THE CONSULTANT OF ALL CHANGES.

CONSTRUCTION AND EXCAVATION WASTES, OVERBURDEN, SOIL, OR OTHER SUBSTANCES DELETERIOUS TO THE AQUATIC LIFE SHALL BE DISPOSED OF OR PLACED IN SUCH A MANNER SO AS TO PREVENT THEIR ENTRY INTO ANY WATERCOURSE, RAVINE OR STORM SEWER SYSTEM.


# 3. SURVEY

- 3.1. GEODETIC INFORMATION IS IN UTM ZONE 10 CVD2013.
- CONSTRUCTION LAYOUT SURVEY IS THE RESPONSIBILITY OF THE CONTRACTOR AND SHALL BE CONSIDERED INCIDENTAL TO THE WORK. WORKPOINTS AND DIGITAL LAYOUT FILES WILL BE PROVIDED ON ISSUED FOR CONSTRUCTION DRAWINGS.
- SURVEY CONTROL BENCHMARKS WILL BE PROVIDED BY THE CONSULTANT FOR THE CONTRACTOR'S USE.


# DRAWING INDEX

| 22107-C-001  | <br>GENERAL NOTES                 |
|--------------|-----------------------------------|
| 22107-C-102  | <br>OVERALL SITE PLAN             |
| 22107-C-201  | <br>SITE A PLAN AND PROFILE       |
| 22107-C-202  | <br>SITE A PLAN AND PROFILE       |
| 22107-C-203  | <br>SITE B PLAN AND PROFILE       |
| 22107-C-204  | <br>SITE C PLAN AND PROFILE       |
| 22107-C-205  | <br>SITE D PLAN AND PROFILE       |
| 22107-C-206  | <br>SITE F PLAN AND PROFILE       |
| 22107-C-207  | <br>SITE F PLAN AND PROFILE       |
| 22107-C-301  | <br>TYPICAL CROSS SECTION         |
| 22107-C-400  | <br>PROPOSED RIPARIAN RESTORATION |
| 22107-C-401  | <br>RESTORATION DETAILS           |
| 22107-C-1001 | <br>CROSS SECTIONS SITE A         |
| 22107-C-1002 | <br>CROSS SECTIONS SITE B         |
| 22107-C-1003 | <br>CROSS SECTIONS SITE C         |
| 22107-C-1004 | <br>CROSS SECTIONS SITE D         |
| 22107-C-1005 | <br>CROSS SECTIONS SITE F         |
|              |                                   |

# LEGEND

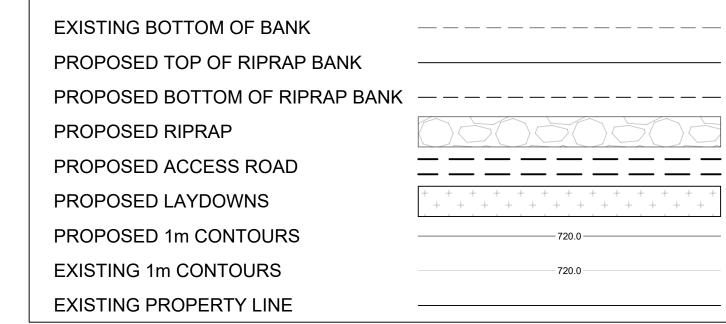

EXISTING TOP OF BANK

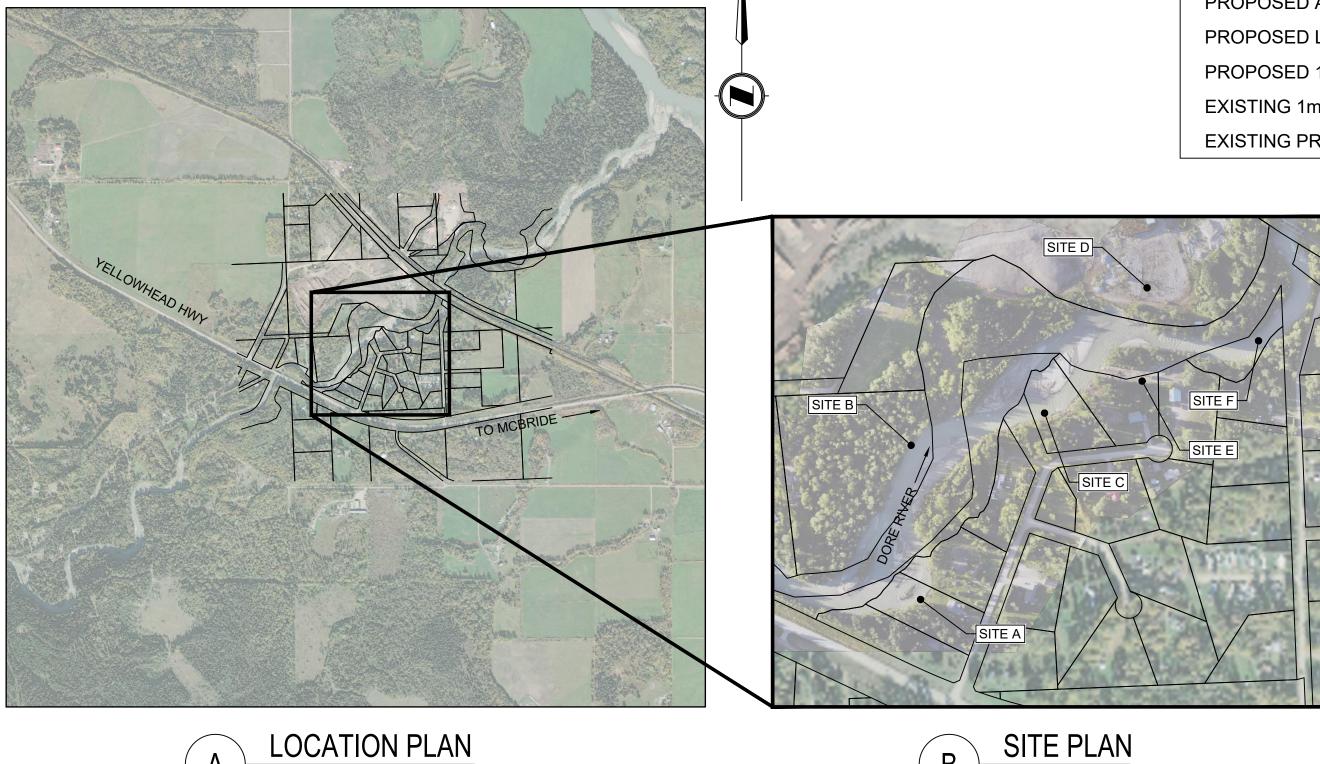



SITE PLAN
SCALE 1:5000

Approved Sealed

|           |                   |       |   |    | THIS DRAWING AND DESIGN IS THE PROPERTY OF McELHANNEY AND SHALL NOT BE USED, REUSED OR REPRODUCED WITHOUT THE CONSENT OF McELHANNEY. McELHANNEY WILL NOT BE HELD RESPONSIBLE FOR THE IMPROPER OR UNAUTHORIZED USE OF THIS DRAWING AND DESIGN.   |      |
|-----------|-------------------|-------|---|----|---|------|
|           |                   |       |   |    | THIS DRAWING AND DESIGN HAS BEEN PREPARED FOR THE CLIENT IDENTIFIED, TO MEET THE STANDARDS AND REQUIREMENTS OF THE APPLICABLE PUBLIC AGENCIES AT THE TIME OF PREPARATION. McELHANNEY, ITS EMPLOYEES, SUBCONSULTANTS AND AGENTS WILL NOT BE LIABLE FOR ANY LOSSES OR OTHER CONSEQUENCES RESULTING FROM THE USE OR RELIANCE UPON, OR ANY CHANGES MADE TO, THIS DRAWING, BY ANY THIRD PARTY, INCLUDING |      |
|           |                   |       |   |    | CONTRACTORS, SUPPLIERS, CONSULTANTS AND STAKEHOLDERS, OR THEIR EMPLOYEES OR AGENTS, WITHOUT McELHANNEY'S PRIOR WRITTEN CONSENT.  INFORMATION ON EXISTING UNDERGROUND FACILITIES MAY NOT BE COMPLETE OR ACCURATE.  |      |
|           |                   |       |   |    | McELHANNEY, ITS EMPLOYEES AND DIRECTORS ARE NOT RESPONSIBLE NOR LIABLE FOR THE  |      |
| 024-03-04 | ISSUED FOR TENDER | EO    | KB  | DJ | LOCATION OF ANY UNDERGROUND CONDUITS, PIPES, CABLES OR OTHER FACILITIES WHETHER SHOWN OR OMITTED FROM THIS PLAN. PRIOR TO CONSTRUCTION CONTRACTOR SHALL EXPOSE  |      |
| Date      | Description       | Drawn | vn Design App'd LOCATIONS OF ALL EXISTING FACILITIES BY HENGINEER OF POTENTIAL CONFLICTS. |    | LOCATIONS OF ALL EXISTING FACILITIES BY HAND DIGGING OR HYDROVAC AND ADVISE THE ENGINEER OF POTENTIAL CONFLICTS.  | ORIO |

AS NOTED:



PERMIT NUMBER: 1003299 Engineers and Geoscientists of BC

556 North Nechako Road Prince George BC Canada V2K 1A1 T 250 561 2229


REGIONAL DISTRICT OF FRASER - FORT GEORGE 155 GEORGE STREET, PRINCE GEORGE, BC, V2L 1P8


DORE RIVER PROPOSED BANK ARMORING NOTES


001


Project Number


2341-21107-01

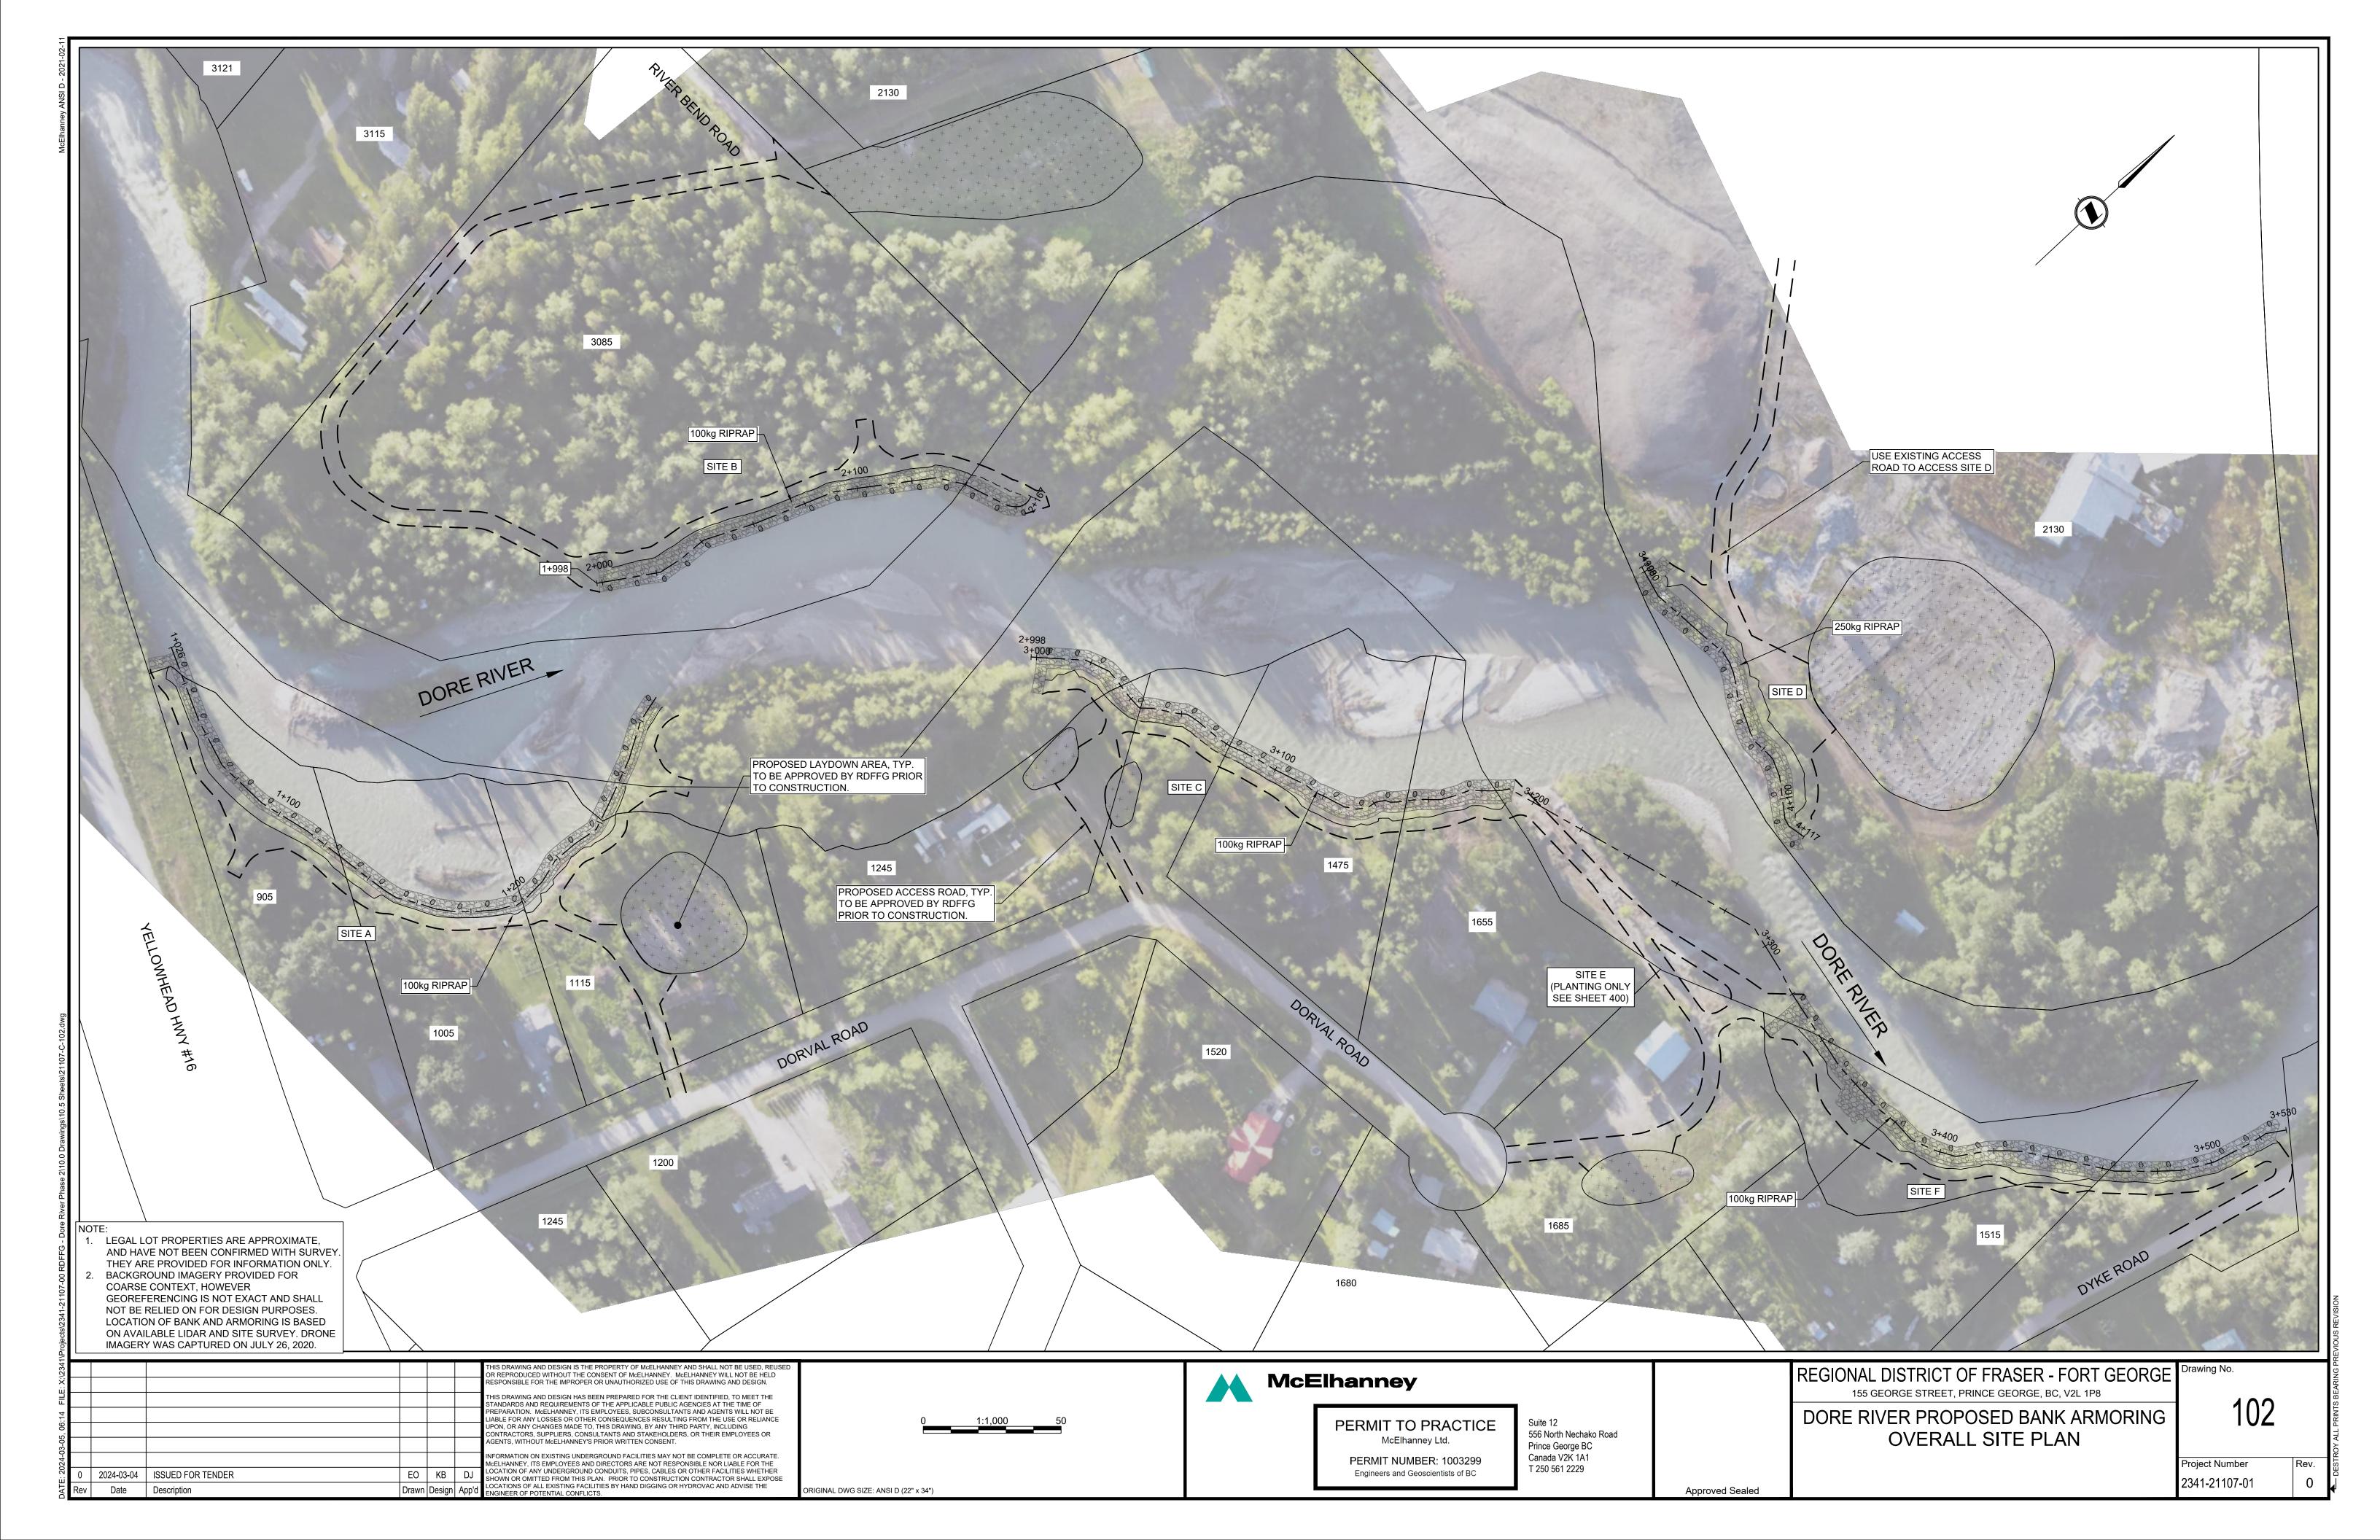


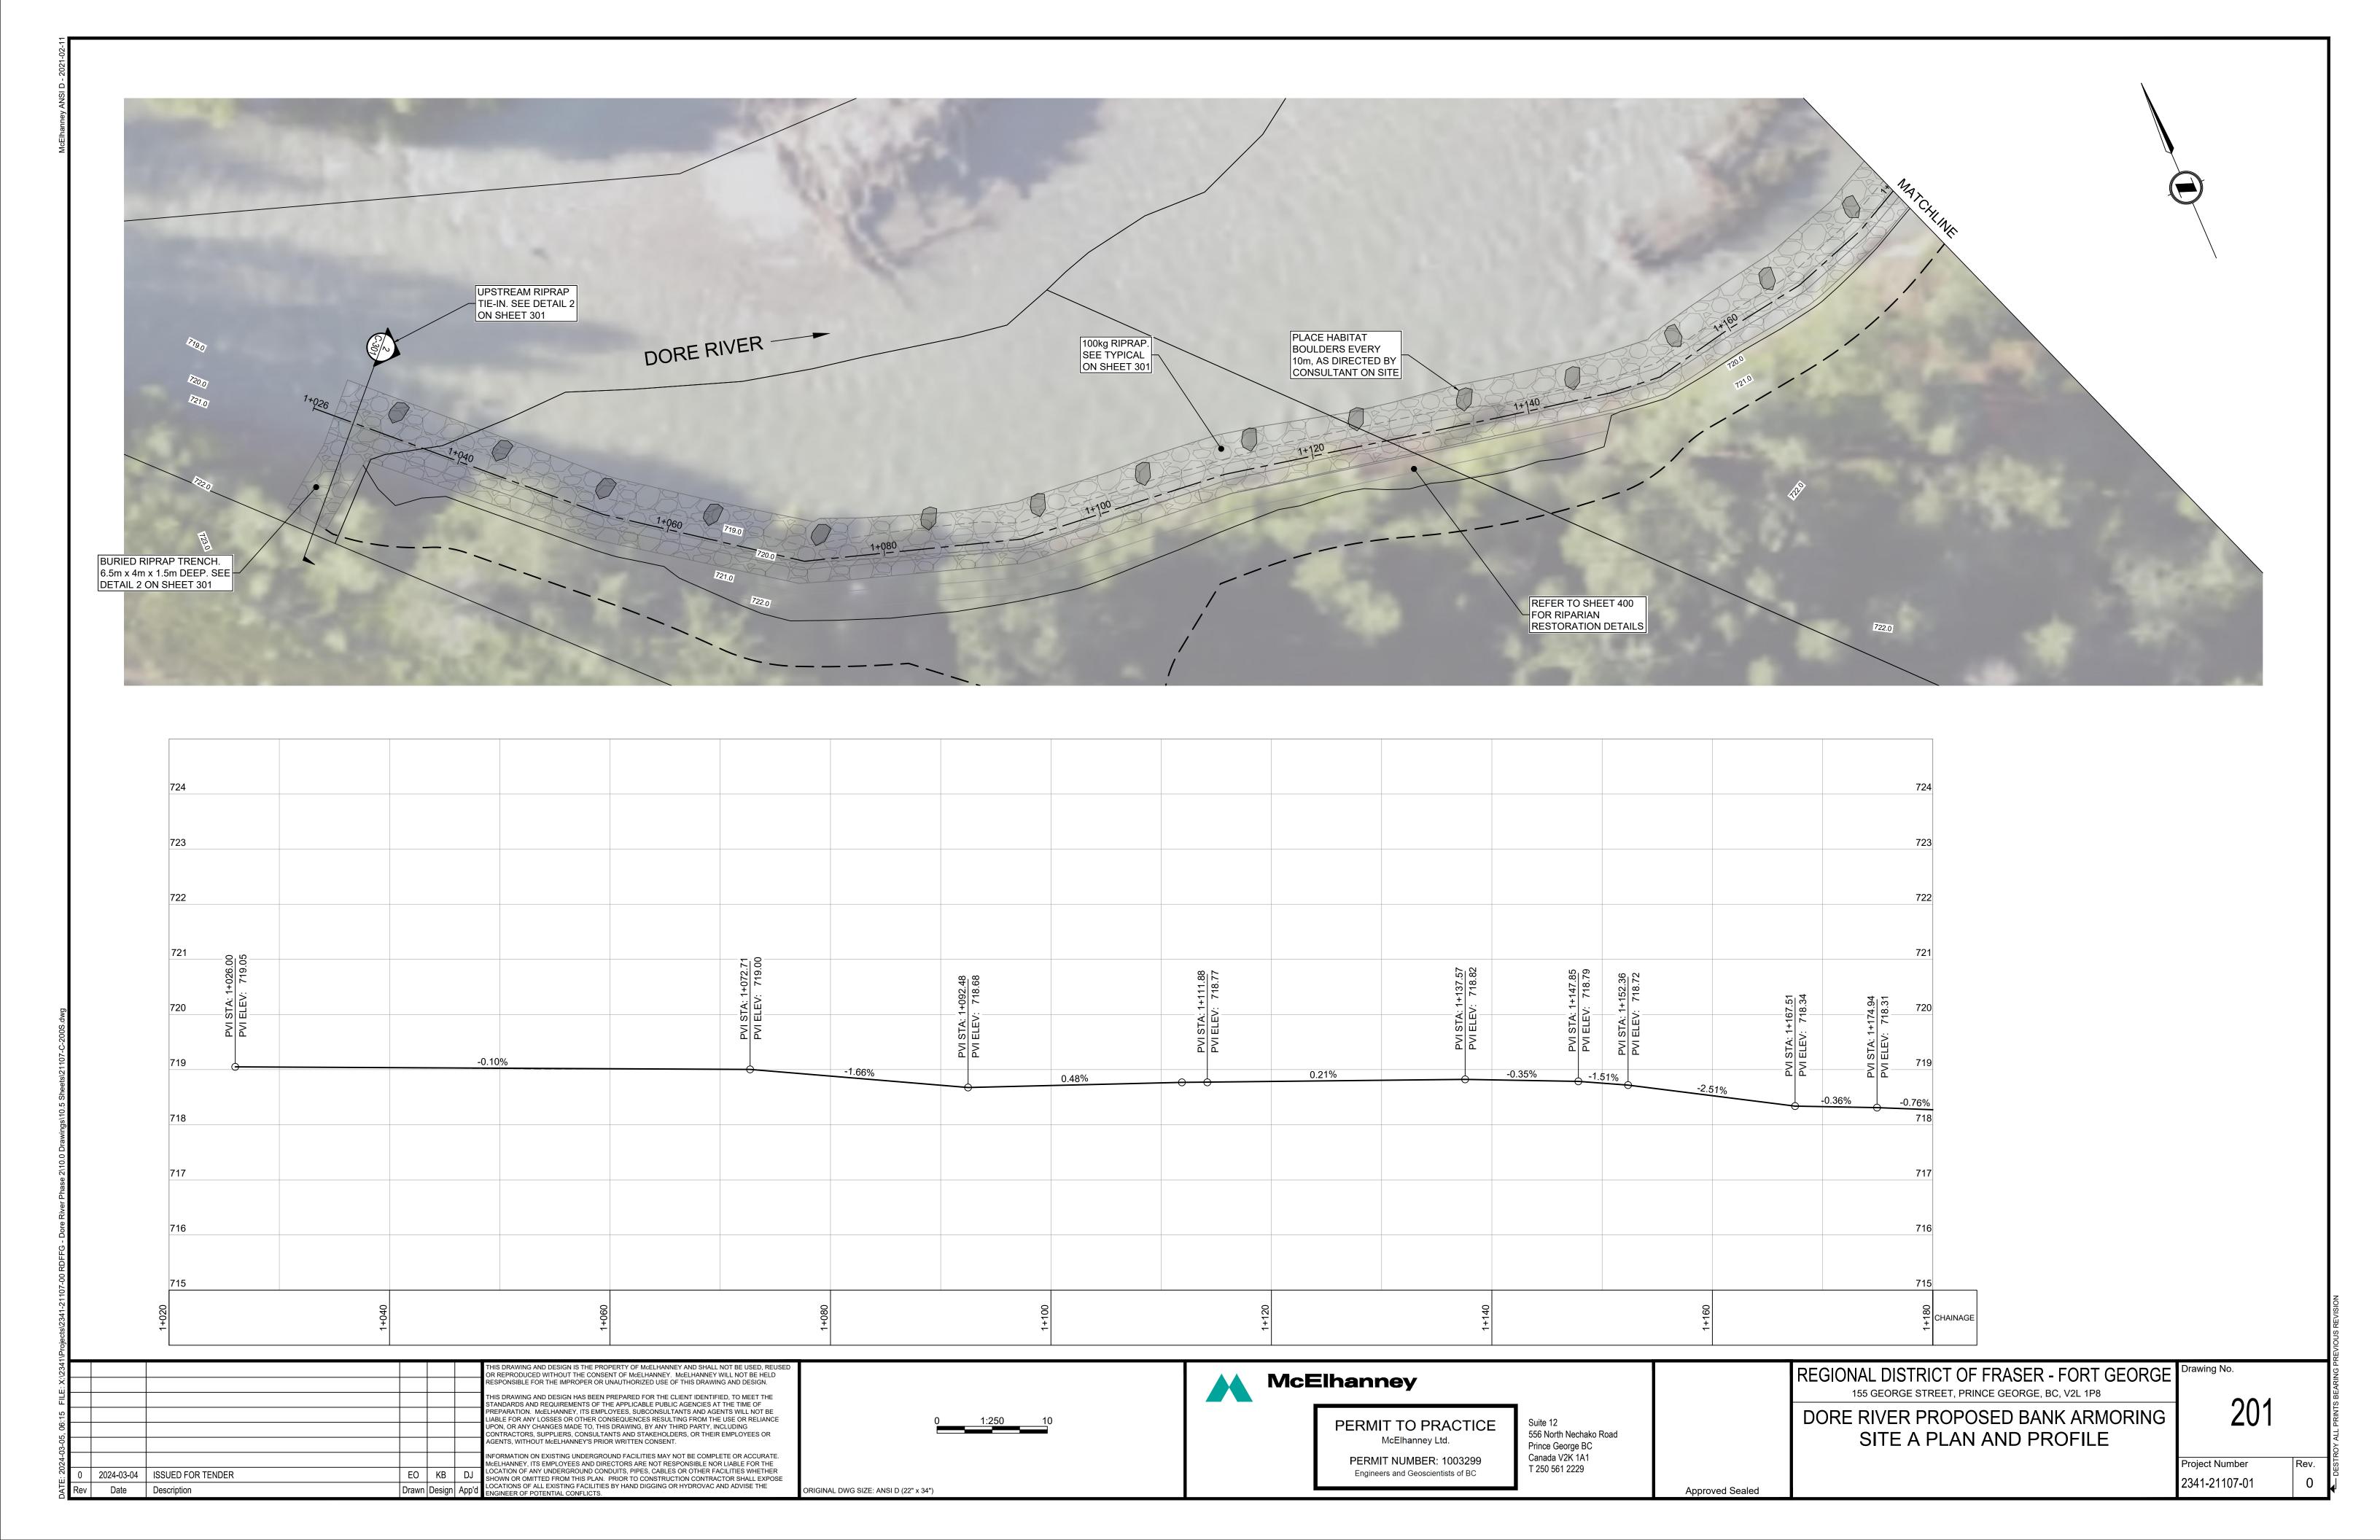


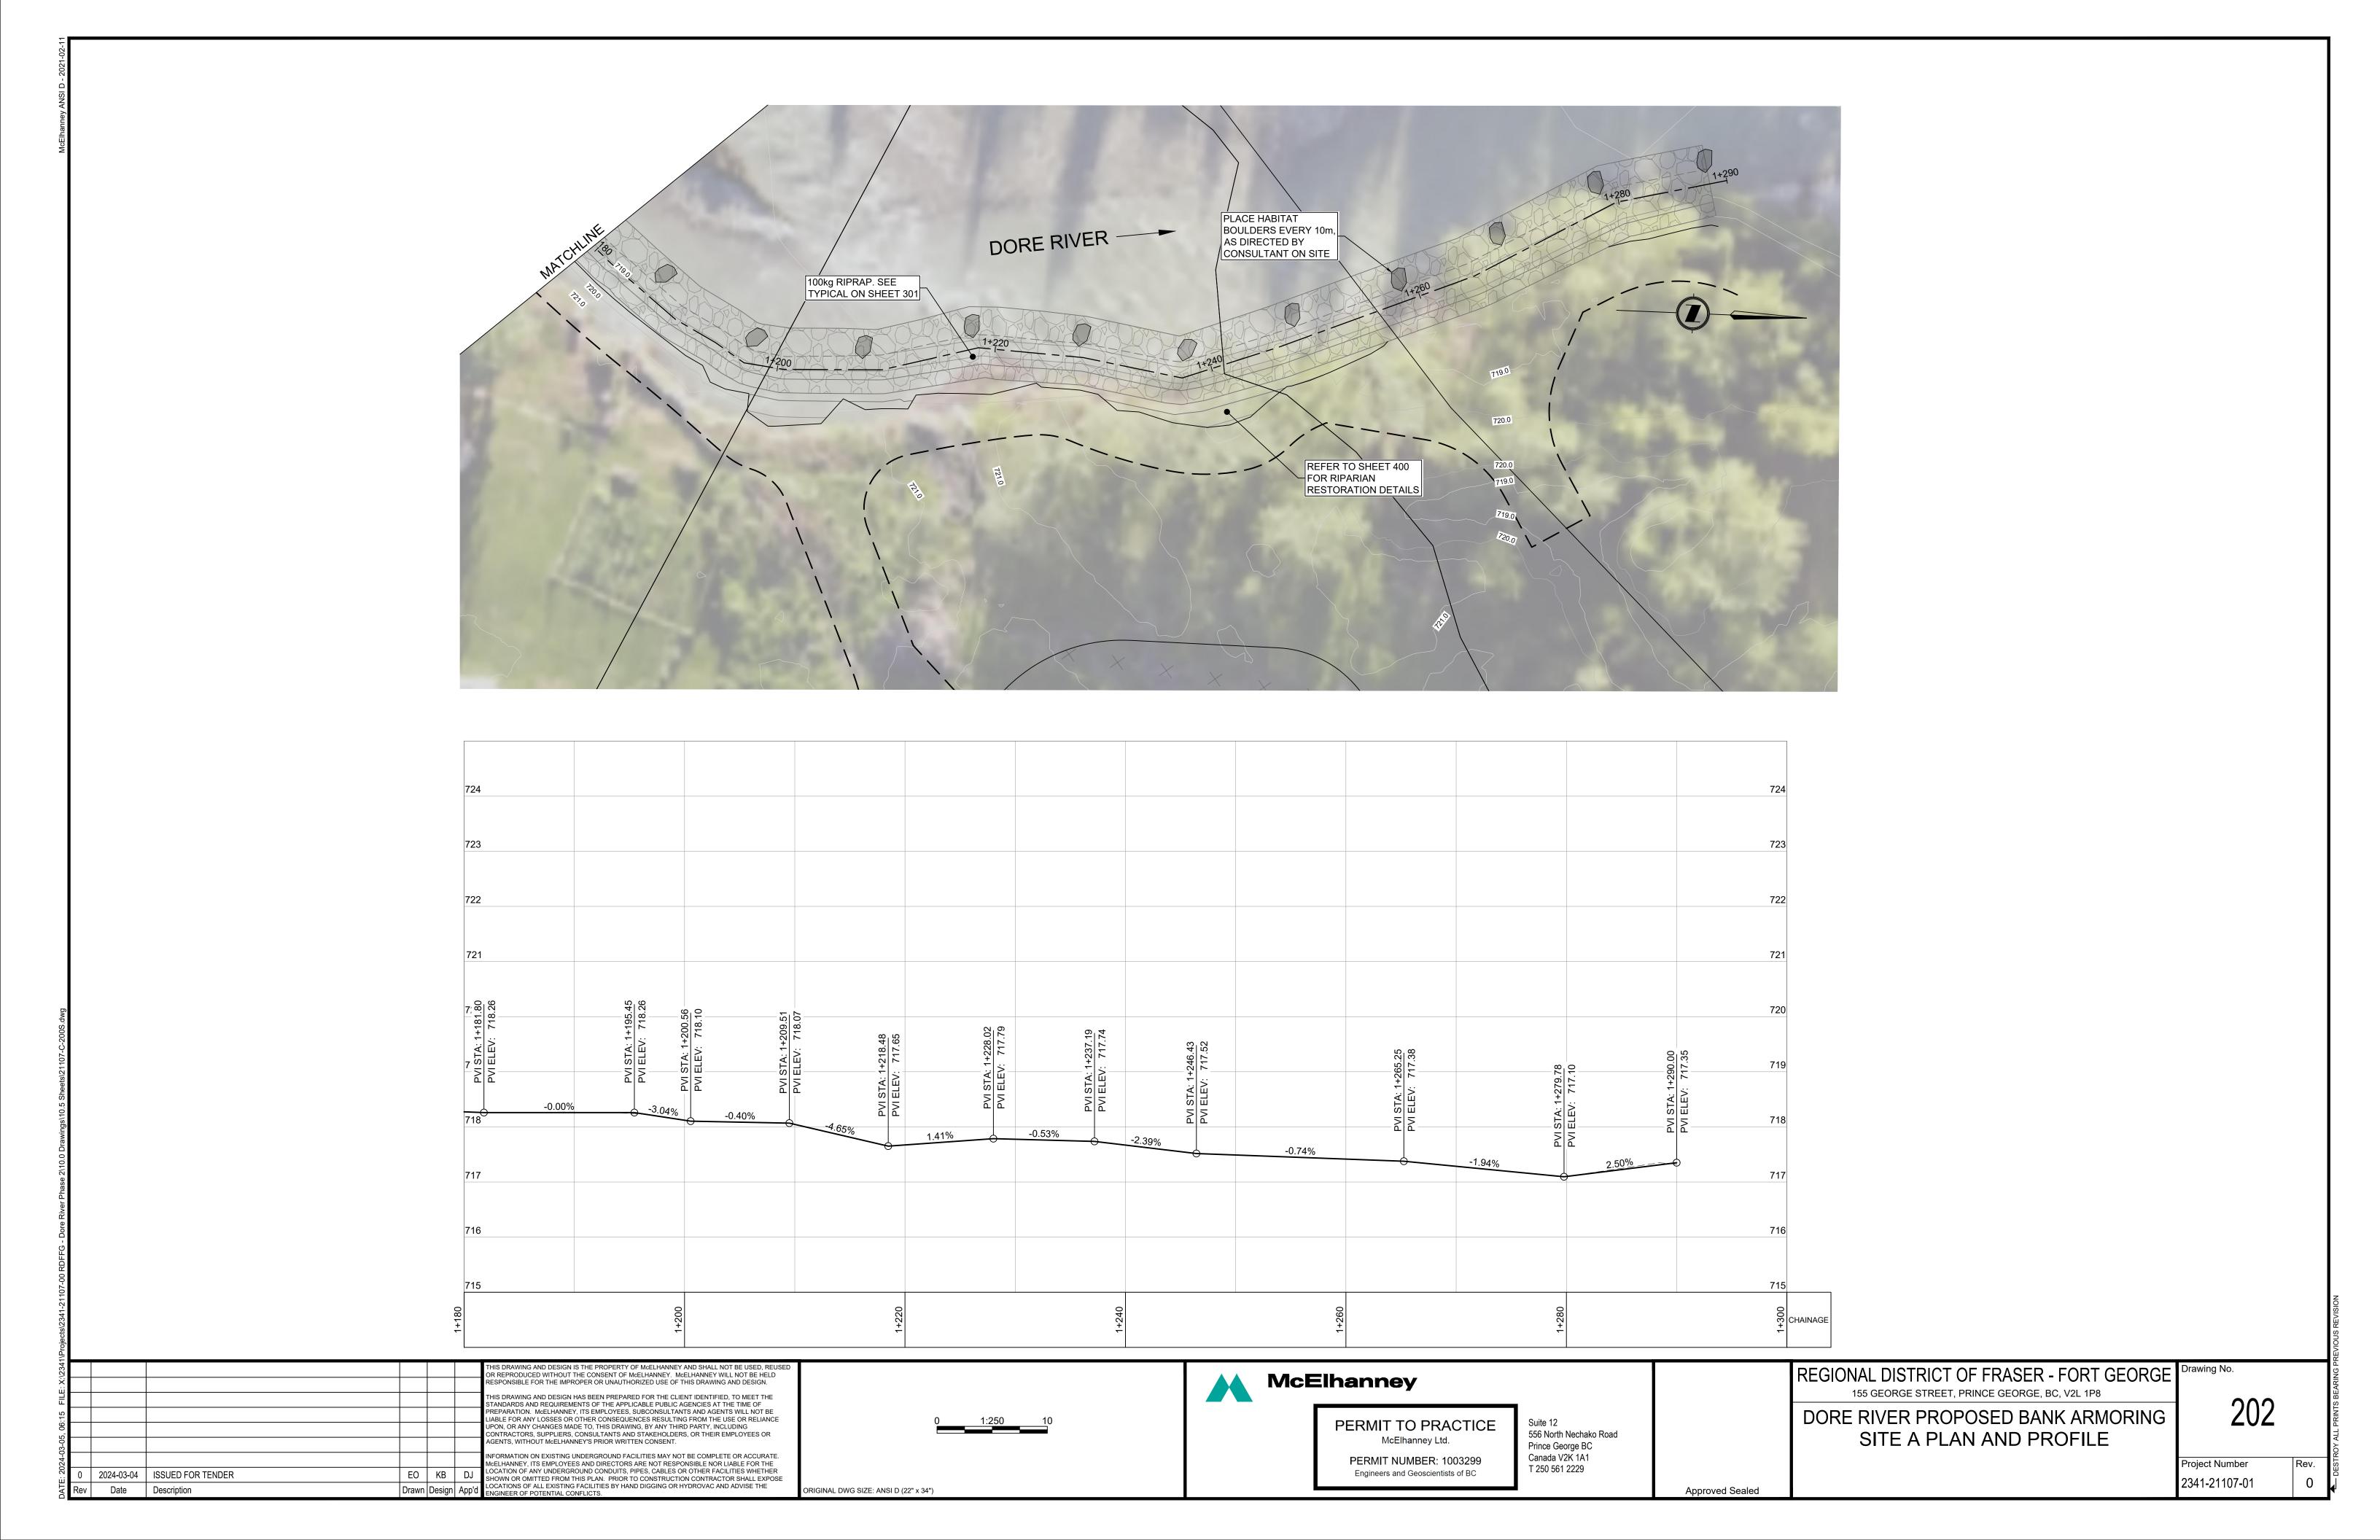


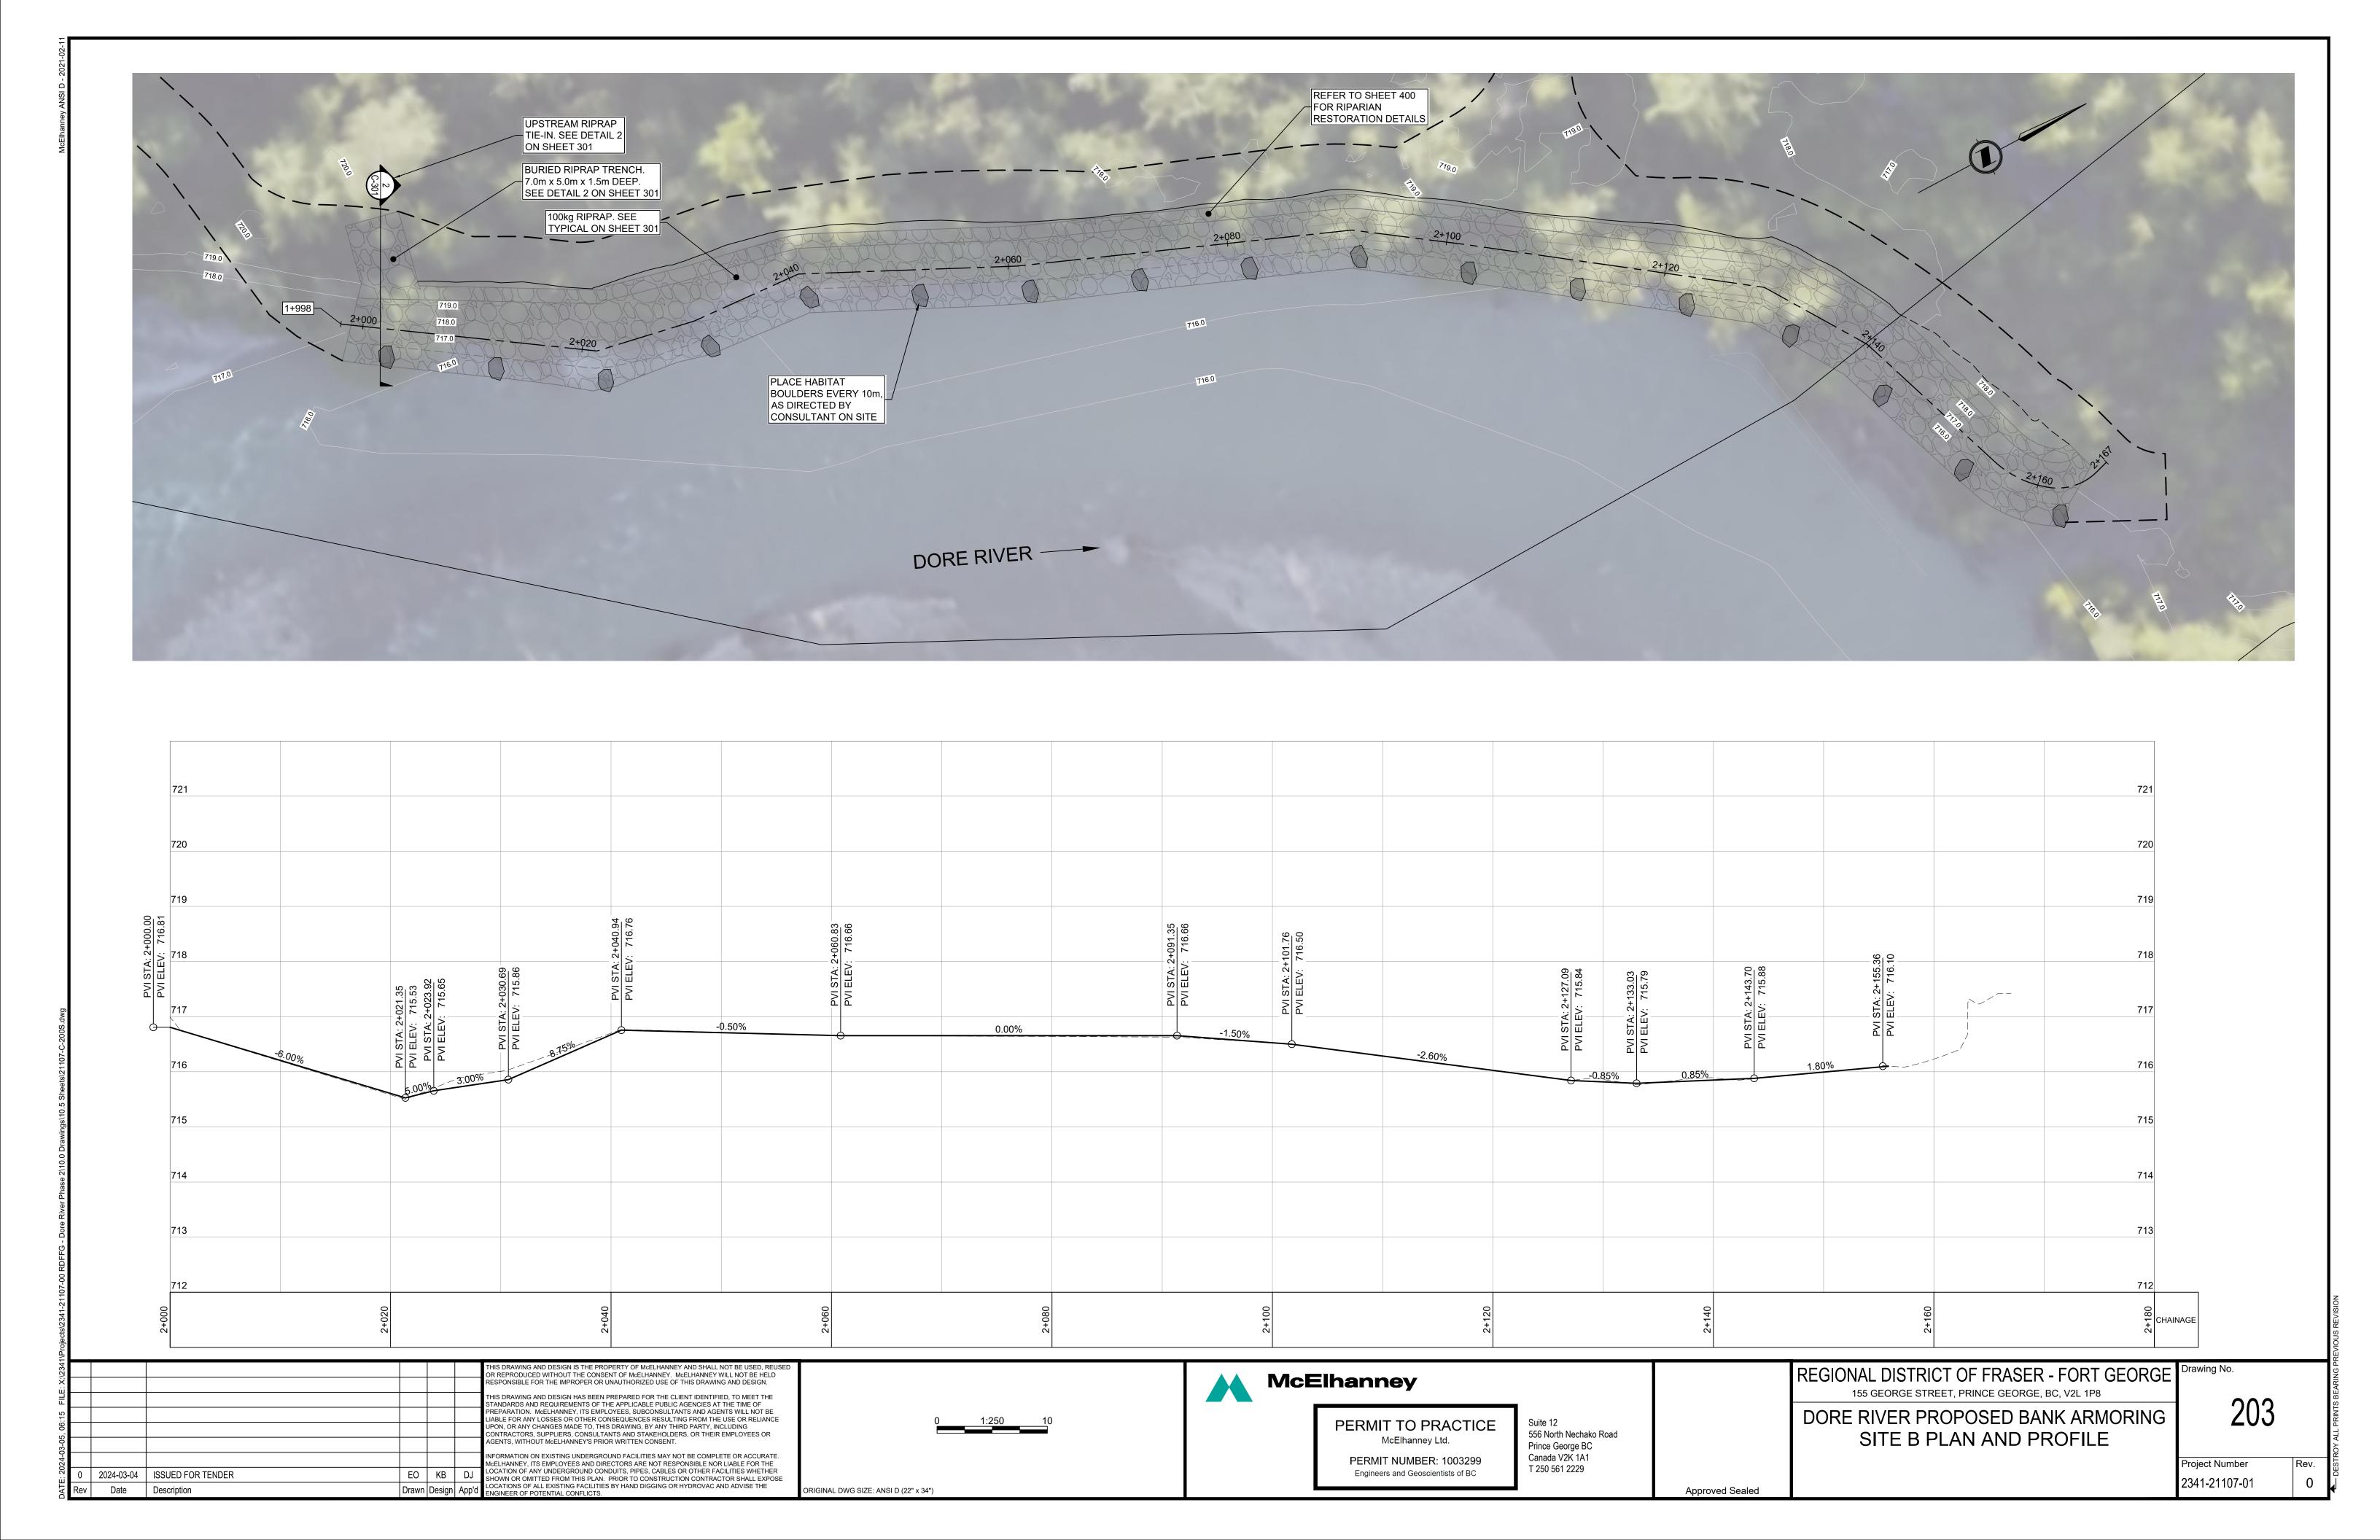


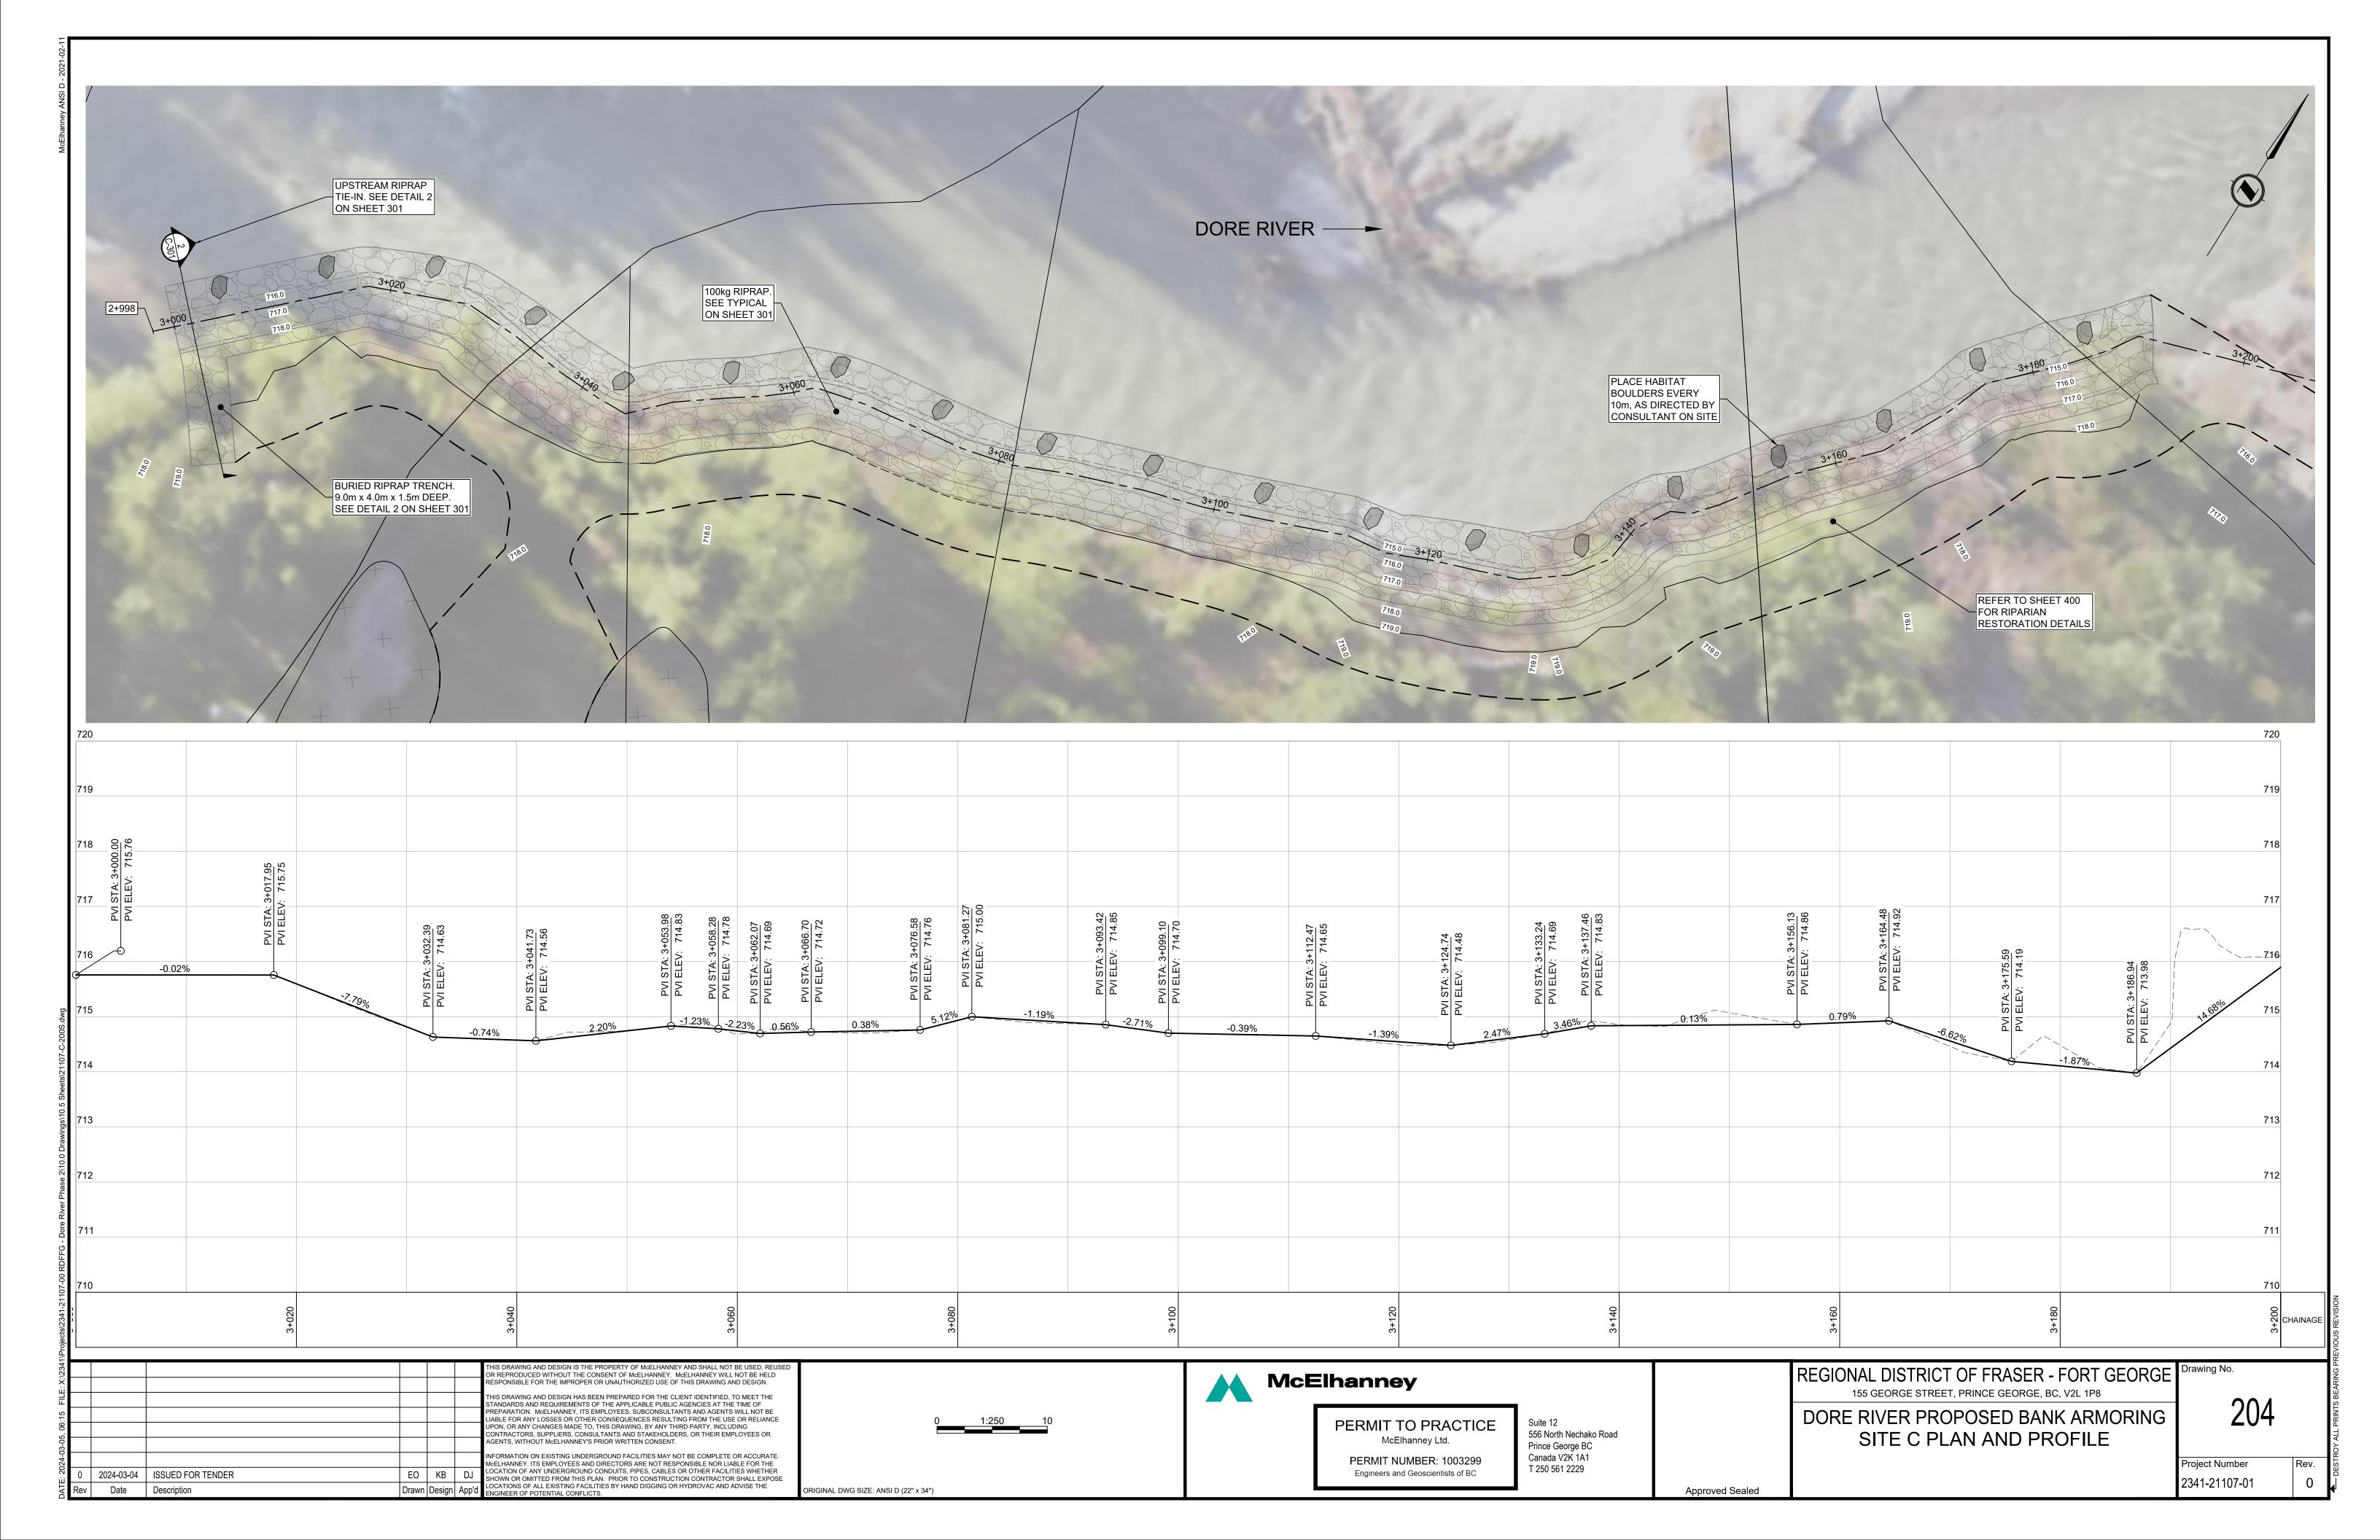

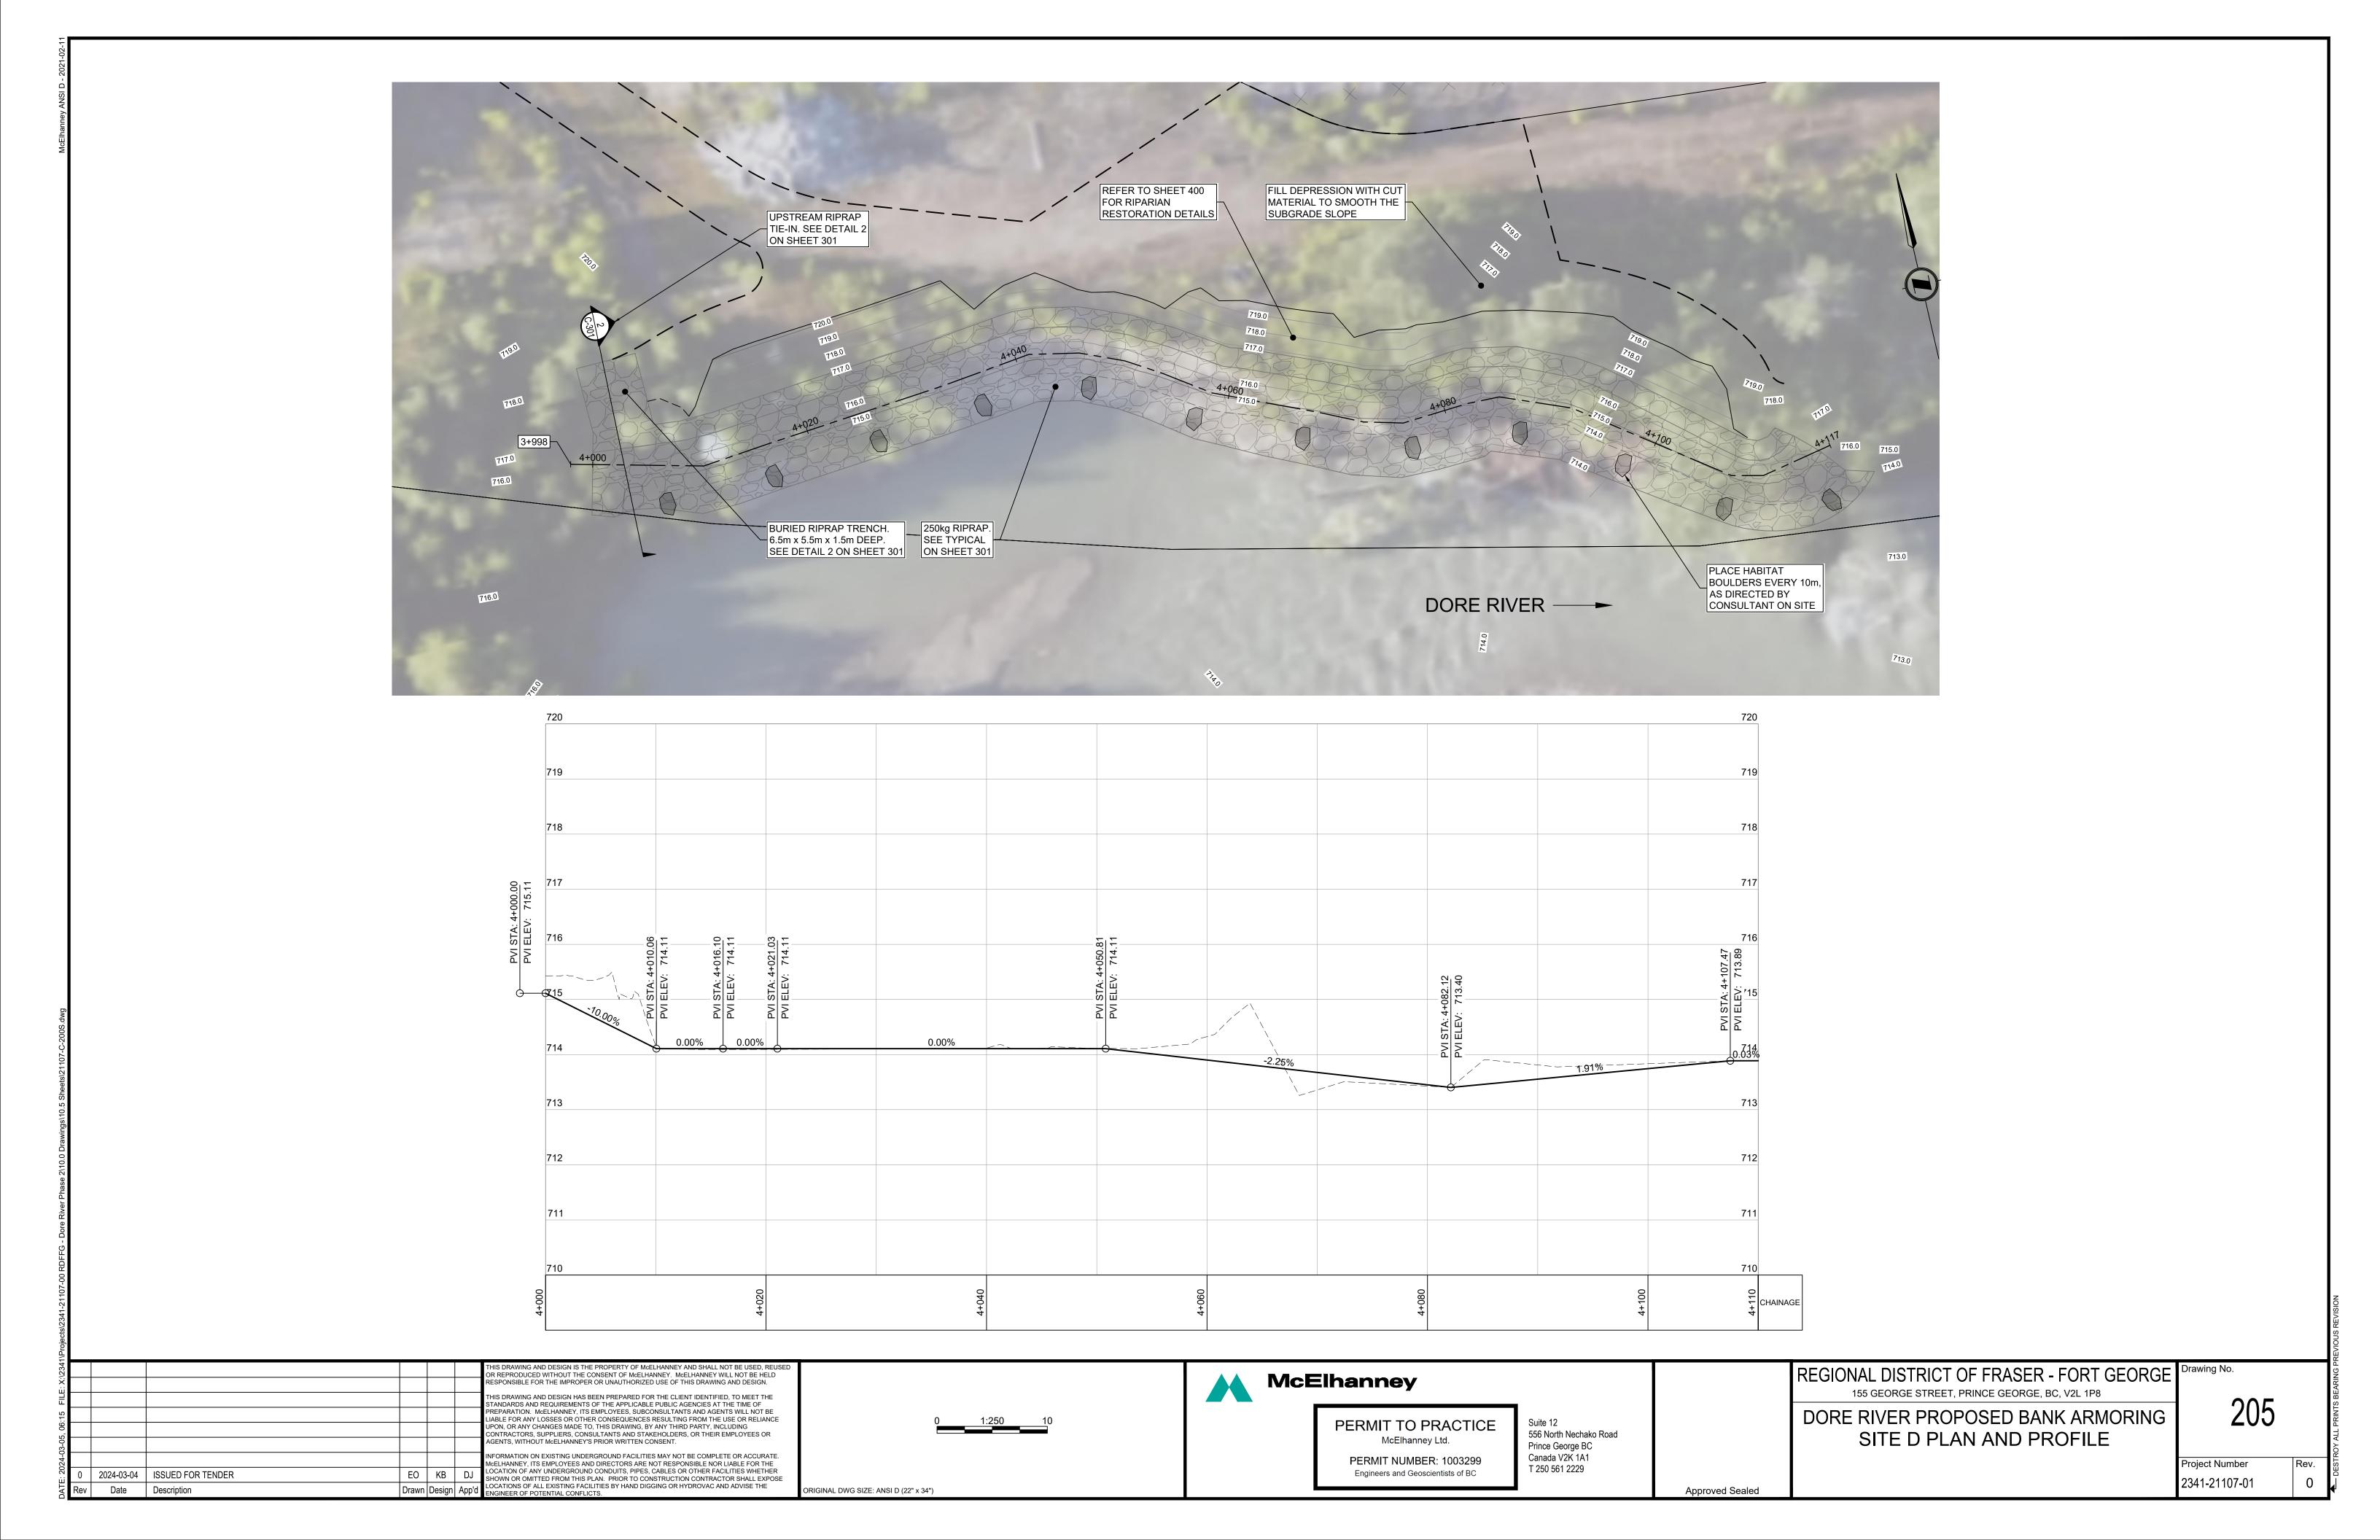

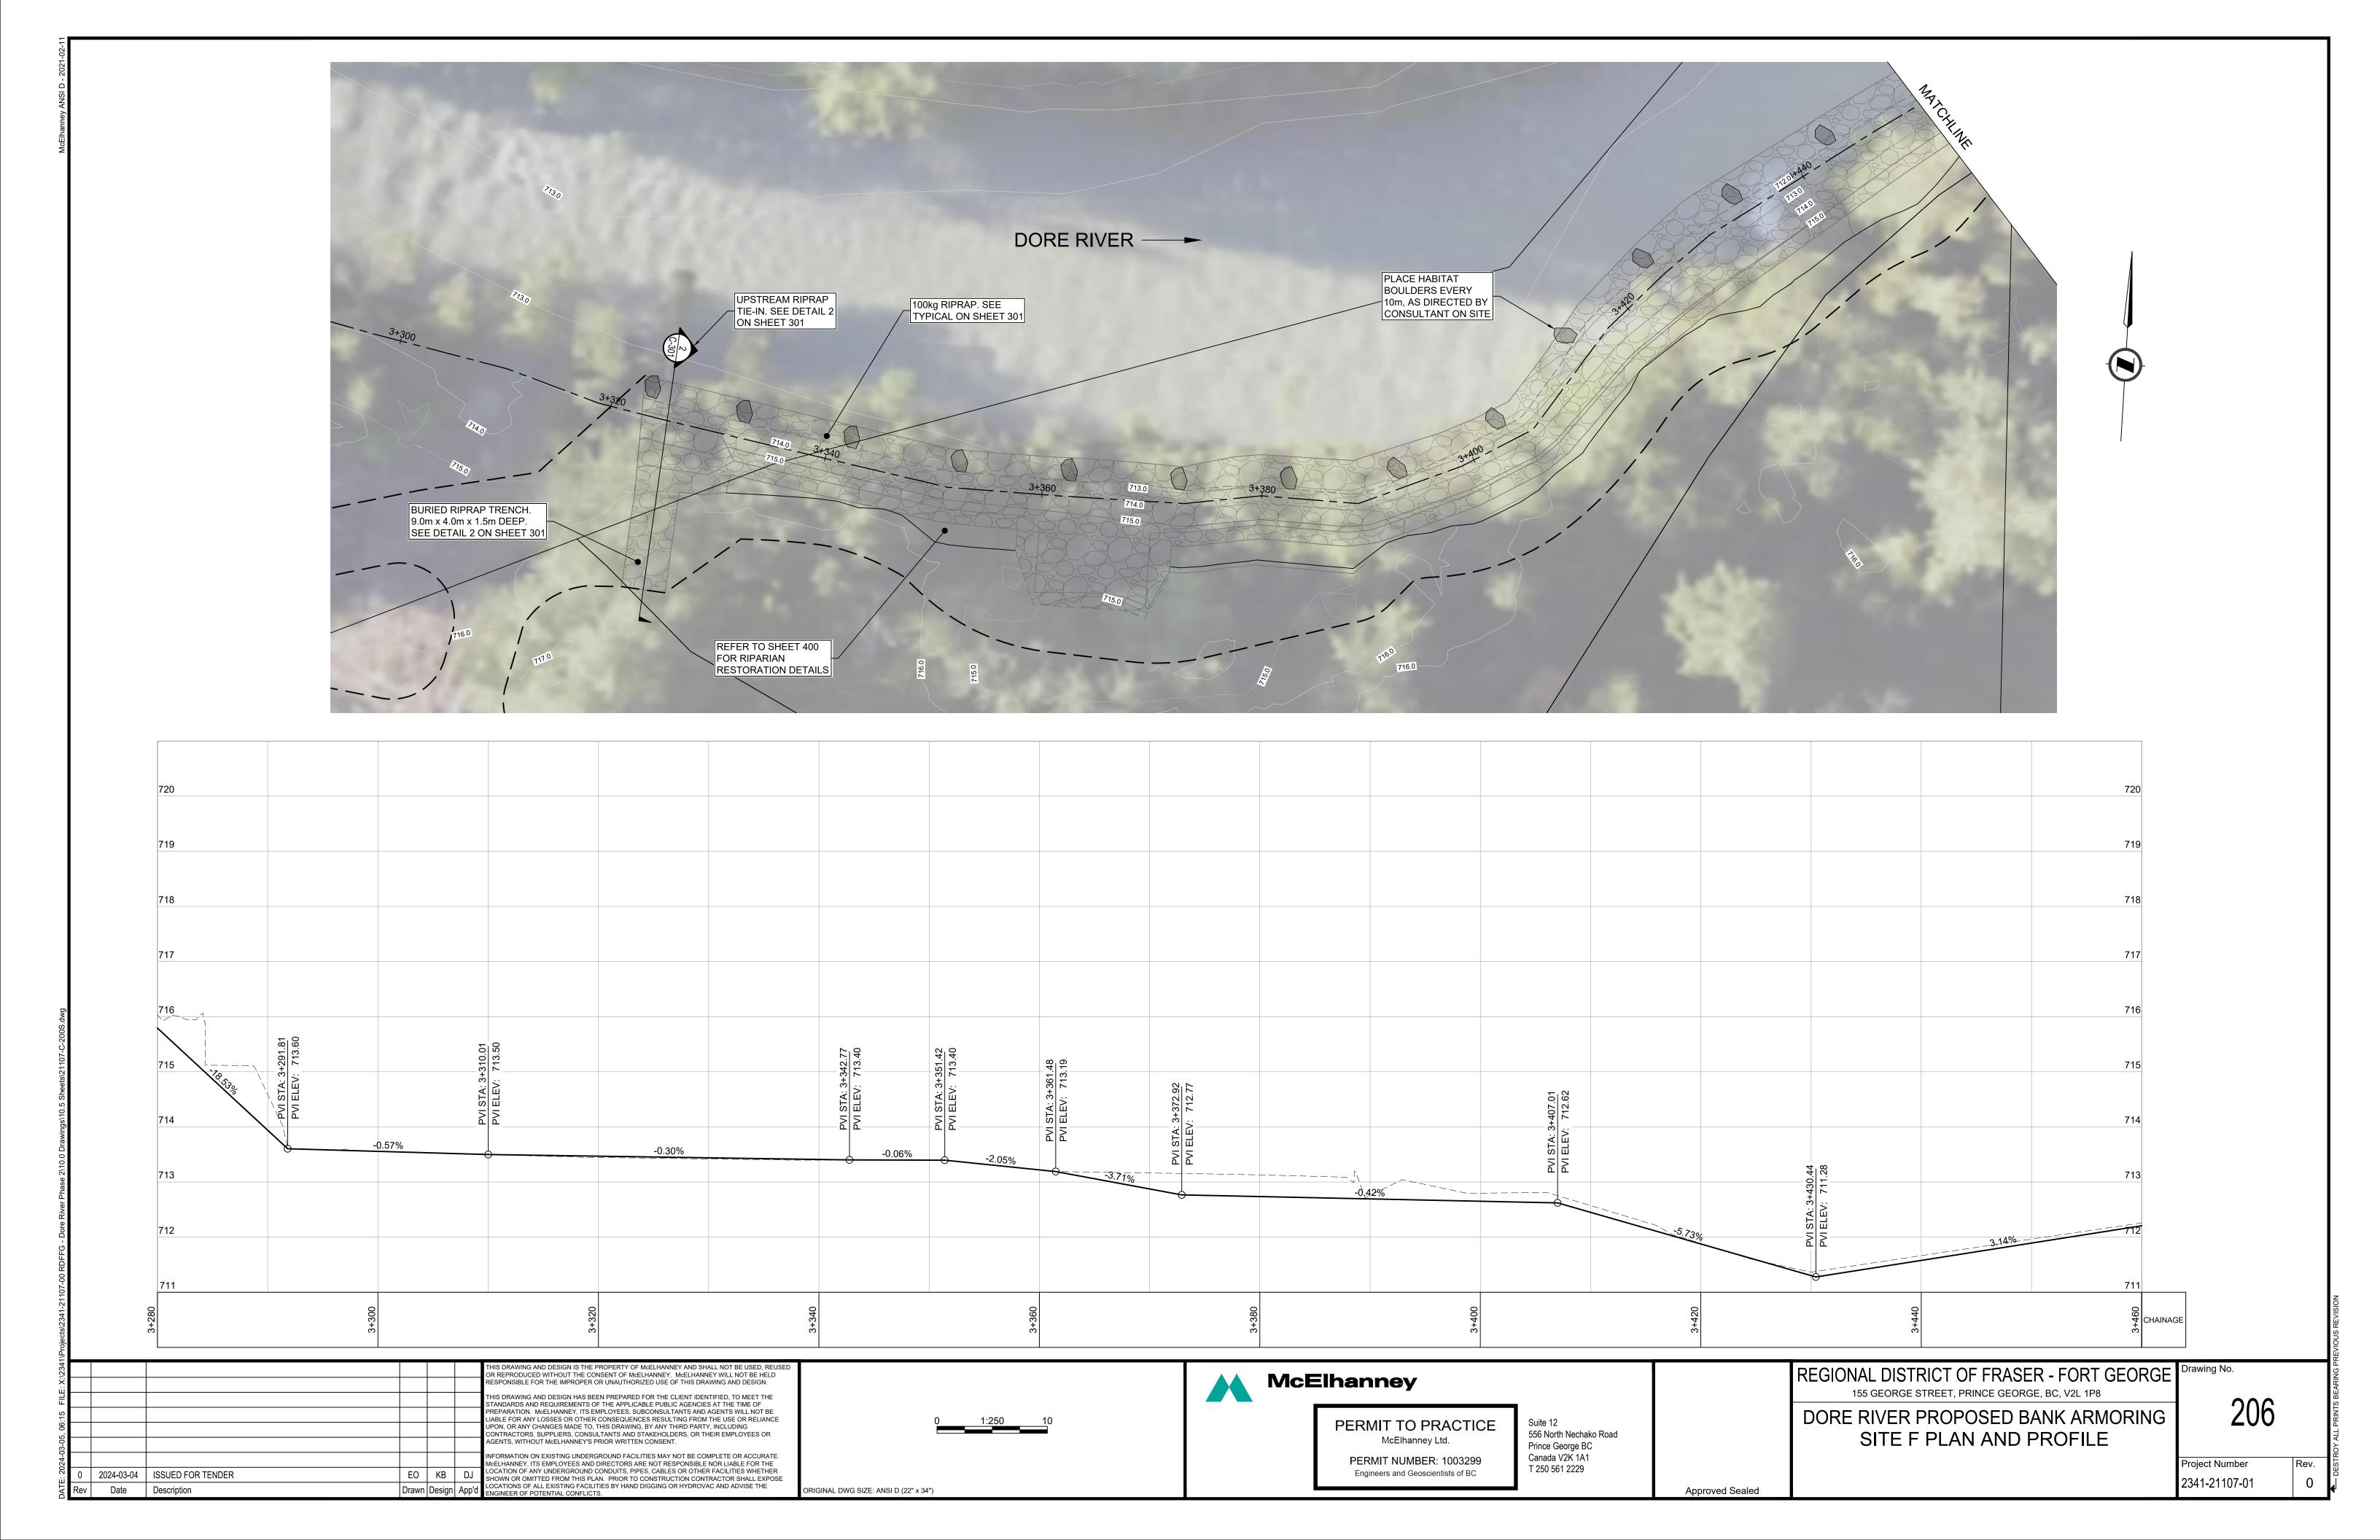

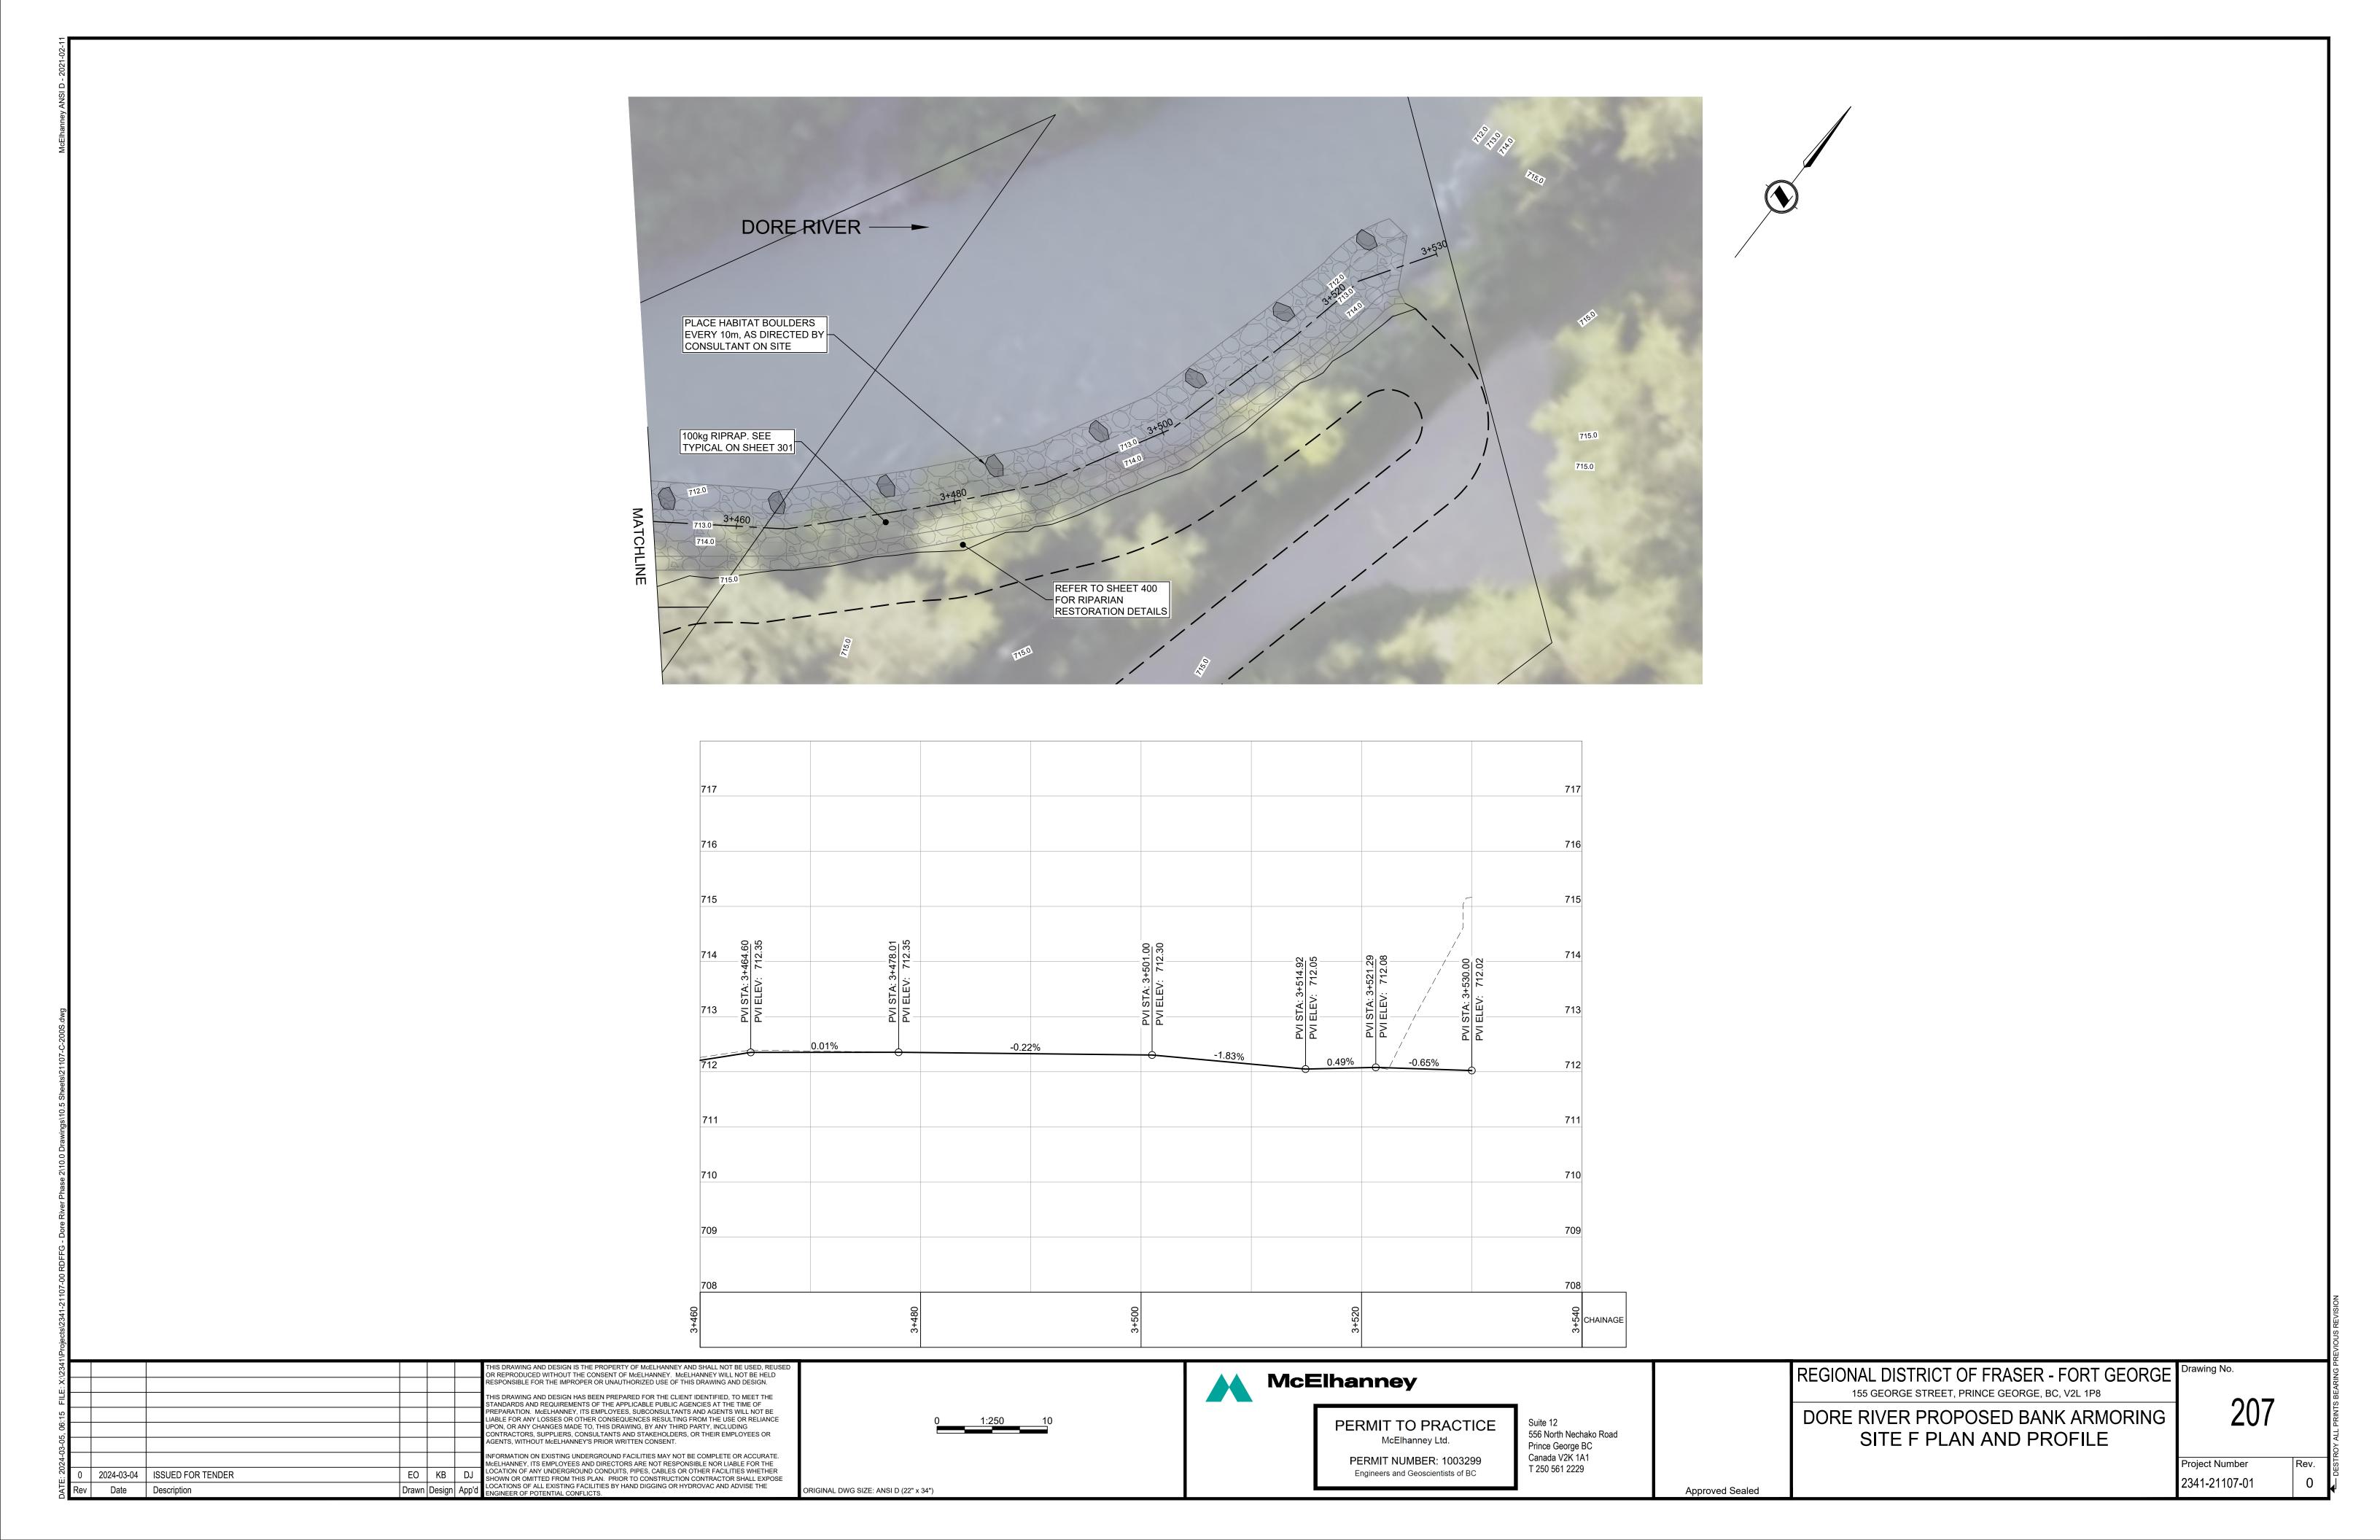

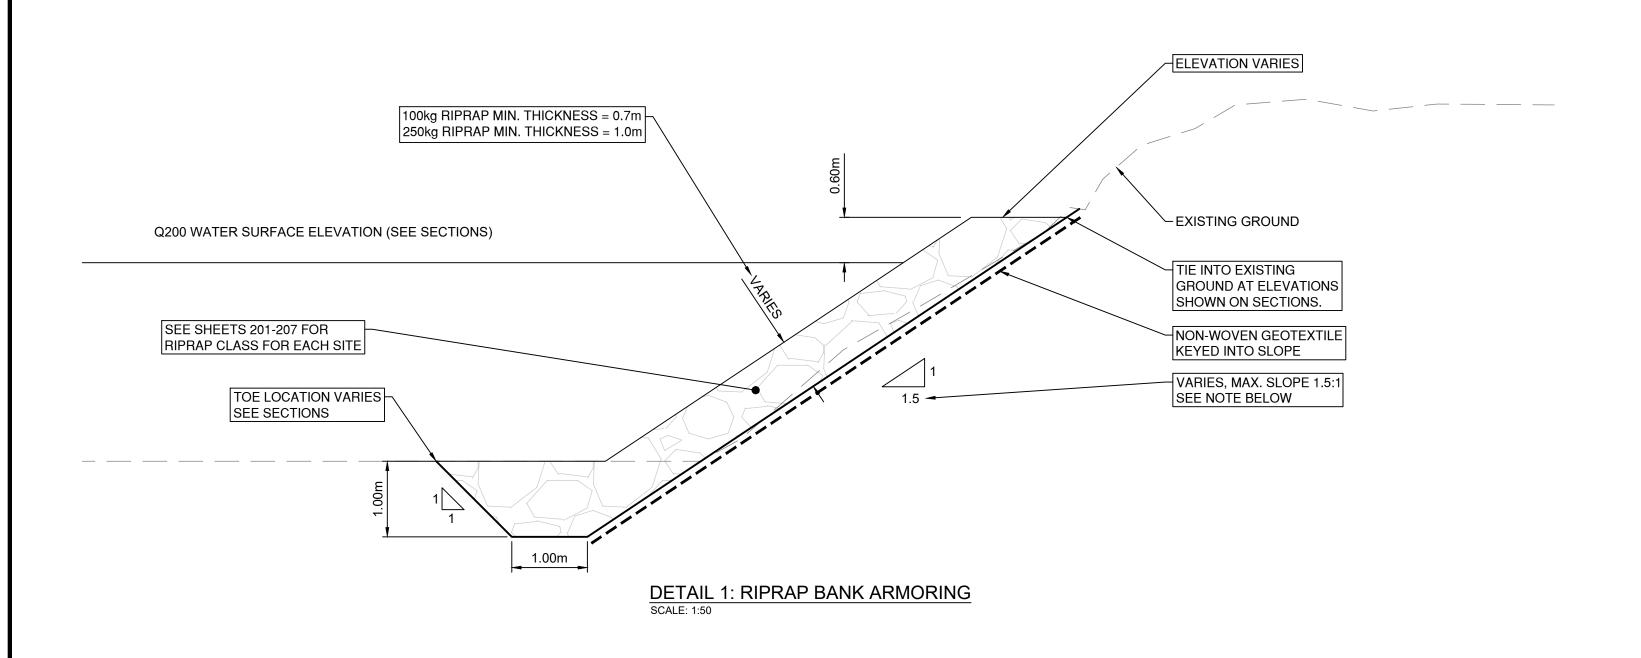

# SEE SHEETS 400 AND 401 FOR PLANTING SPECIFICATIONS GROUND RIPRAP ARMORING, SEE TYPICAL SECTION PLACE 800mm - 1000mm Ø HABITAT BOULDER AS PER SHEETS 201-207 AND AS DIRECTED BY ENGINEER ON SITE EMBED HABITAT BOULDER MIN. 40% OF DIAMETER HABITAT FEATURES TYPICAL DETAIL


# NOTES ON PREPARATION OF RIVERBANK:


IN ORDER TO AVOID SLIVER FILLS AND TO MINIMIZE EXCAVATION AND RIPRAP VOLUMES, THE FOLLOWING METHODS MAY BE USED, AS APPROVED BY THE CONTRACT ADMINISTRATOR:

METHOD 1: WHERE BANK IS OVER STEEPENED, EXCAVATE THE BANK TO ACHIEVE 1.5H:1V SUBGRADE SLOPE FOR UNIFORM PLACEMENT OF RIPRAP. SEE METHOD 1

METHOD 2: IF EXISTING BANK HAS A SLOPE SHALLOWER THAN 1.5H:1V, SMOOTH EXISTING BANK TO PREPARE SUBGRADE FOR UNIFORM PLACEMENT OF RIPRAP.


METHOD 3: IF EXISTING BANK UNDULATES AND COULD BENEFIT FROM FILL TO MINIMIZE EXCAVATION AND RIPRAP VOLUMES, CONTRACTOR IS TO PLACE IMPORTED SELF-COMPACTING SLOPE FILL TO PREPARE SUBGRADE FOR UNIFORM PLACEMENT OF RIPRAP.

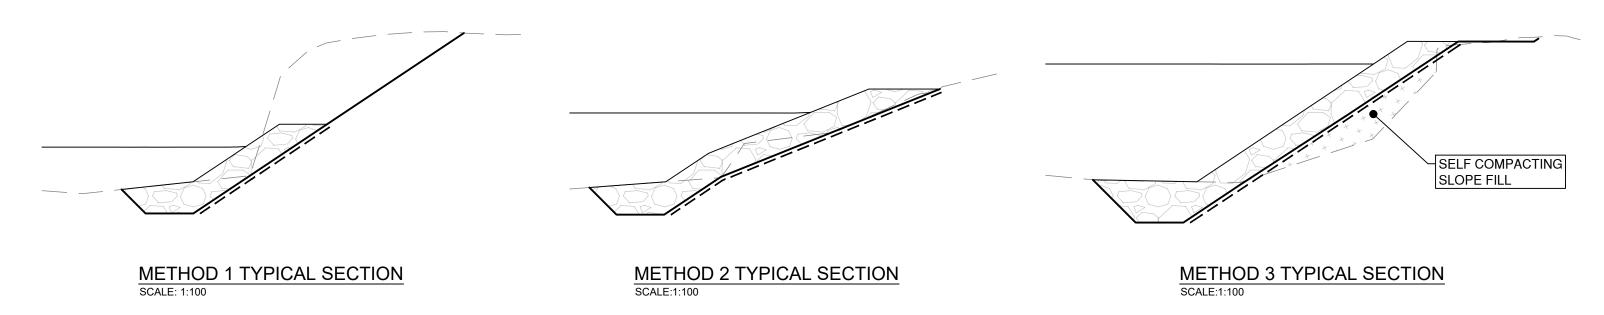

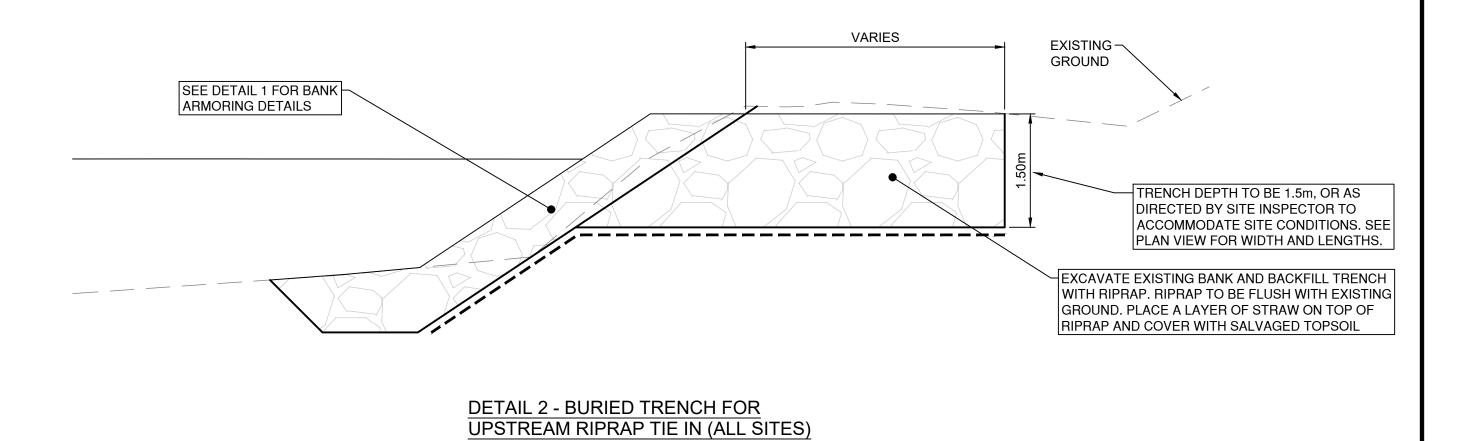

| . 7.1234  |            |                   |       |        |       | THIS DRAWING AND DESIGN IS THE PROPERTY OF McELHANNEY AND SHALL NOT BE USED, REUSED OR REPRODUCED WITHOUT THE CONSENT OF MCELHANNEY. MCELHANNEY WILL NOT BE HELD RESPONSIBLE FOR THE IMPROPER OR UNAUTHORIZED USE OF THIS DRAWING AND DESIGN.   |
|-----------|------------|-------------------|-------|--------|-------|---|
| 0.13 LIFE |            |                   |       |        |       | THIS DRAWING AND DESIGN HAS BEEN PREPARED FOR THE CLIENT IDENTIFIED, TO MEET THE STANDARDS AND REQUIREMENTS OF THE APPLICABLE PUBLIC AGENCIES AT THE TIME OF PREPARATION. MCELHANNEY, ITS EMPLOYEES, SUBCONSULTANTS AND AGENTS WILL NOT BE LIABLE FOR ANY LOSSES OR OTHER CONSEQUENCES RESULTING FROM THE USE OR RELIANCE UPON. OR ANY CHANGES MADE TO. THIS DRAWING. BY ANY THIRD PARTY, INCLUDING |
| n -03, n  |            |                   |       |        |       | CONTRACTORS, SUPPLIERS, CONSULTANTS AND STAKEHOLDERS, OR THEIR EMPLOYEES OR AGENTS, WITHOUT McELHANNEY'S PRIOR WRITTEN CONSENT.   |
| 7-4-7     |            |                   |       |        |       | INFORMATION ON EXISTING UNDERGROUND FACILITIES MAY NOT BE COMPLETE OR ACCURATE.<br>McELHANNEY, ITS EMPLOYEES AND DIRECTORS ARE NOT RESPONSIBLE NOR LIABLE FOR THE   |
| 0         | 2024-03-04 | ISSUED FOR TENDER | EO    | KB     | DJ    | LOCATION OF ANY UNDERGROUND CONDUITS, PIPES, CABLES OR OTHER FACILITIES WHETHER SHOWN OR OMITTED FROM THIS PLAN. PRIOR TO CONSTRUCTION CONTRACTOR SHALL EXPOSE  |
| Rev       | Date       | Description       | Drawn | Design | App'd | LOCATIONS OF ALL EXISTING FACILITIES BY HAND DIGGING OR HYDROVAC AND ADVISE THE ENGINEER OF POTENTIAL CONFLICTS.  |



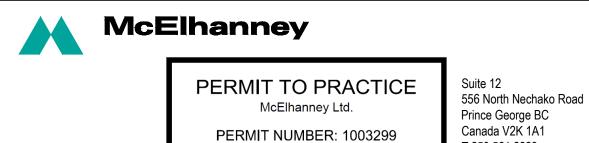

Engineers and Geoscientists of BC


T 250 561 2229

Approved Sealed


| 155 GEORGE STREET, PRINCE GEORGE, BC, V2L 1P8 |
|---|
| DORE RIVER PROPOSED BANK ARMORING             |
| TYPICAL CROSS SECTION                         |


| REGIONAL DISTRICT OF FRASER - FORT GEORGE     | Drawing No. |
|---|-------------|
| 155 GEORGE STREET, PRINCE GEORGE, BC, V2L 1P8 | 004         |
| DORE RIVER PROPOSED BANK ARMORING             | 301         |
| TYPICAL CROSS SECTION                         |             |

Project Number 2341-21107-01

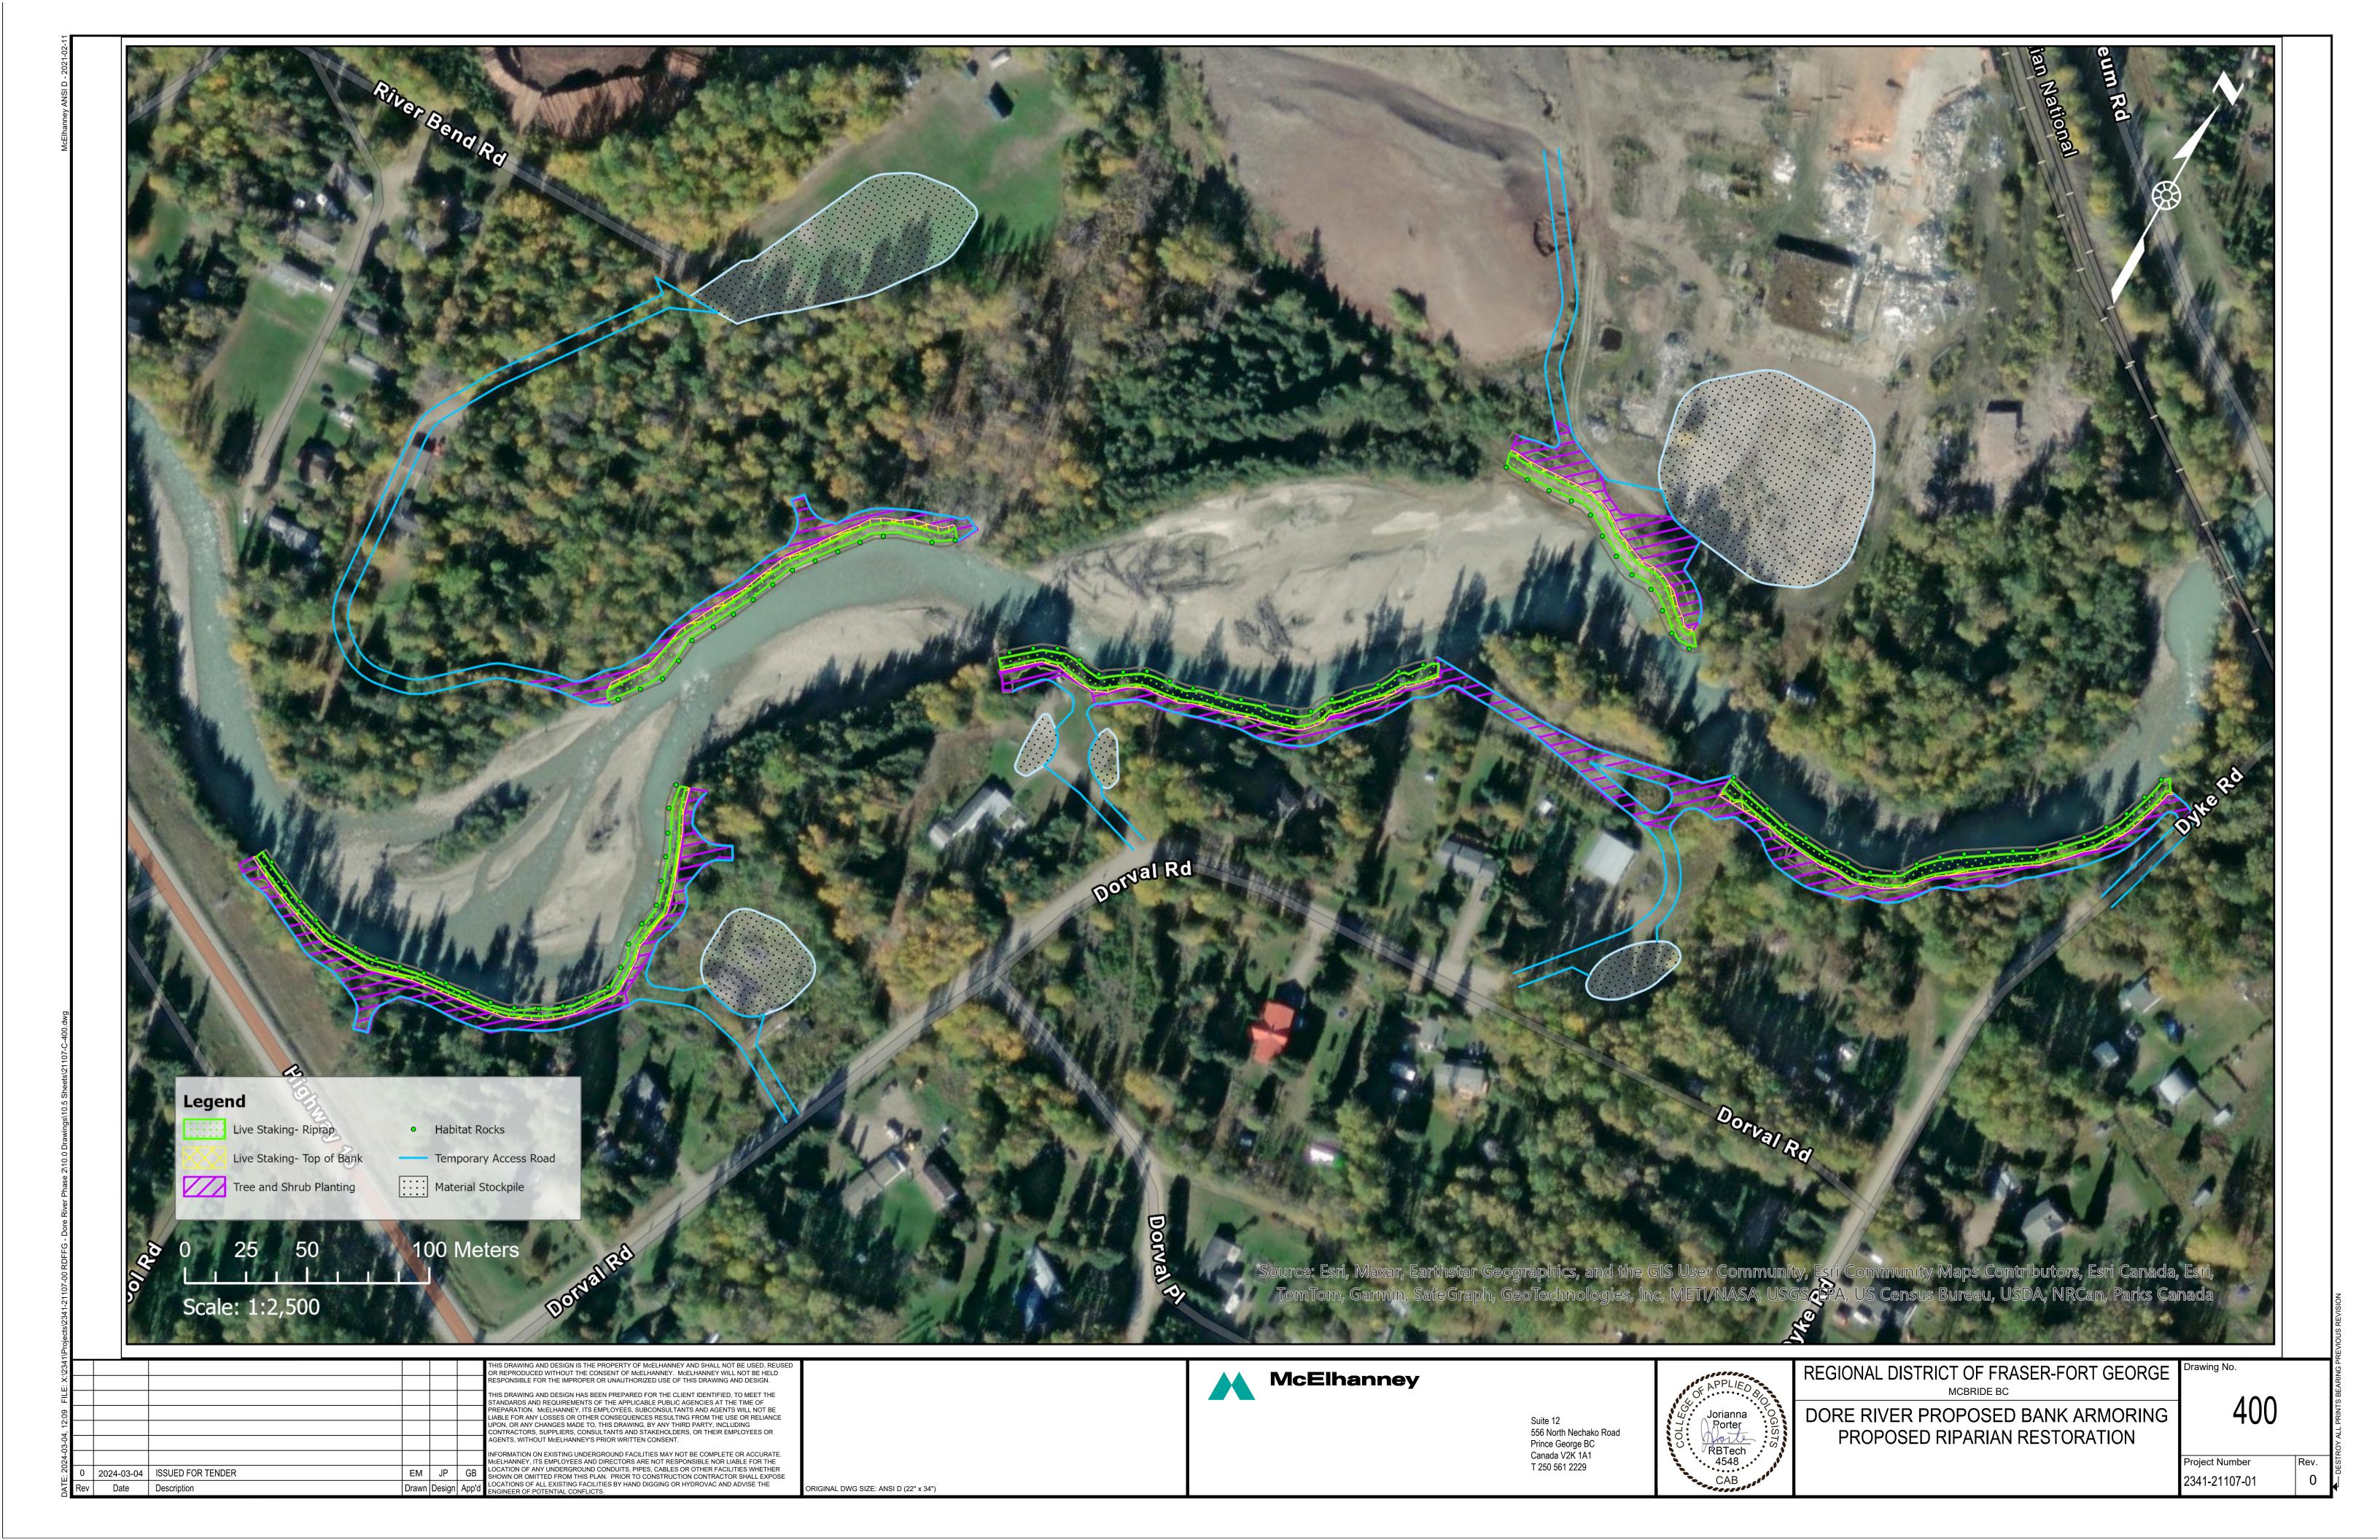


| Red Type At Live Stakes               | (1 Par 1 sq m )                 |  |  |  |                                       | Restoration Guidelines   | 1 All work and materials to conform to the latest edition of the   |
|---------------------------------------|---------------------------------|--|--|--|---------------------------------------|--------------------------|--|
| ROTANICAL NAME                        | COMMON NAME                     | SIZE   | REMARKS  | В  | XX                                    |                          | Canadian Landscape Standard unless specifically otherwise  |
| O TAITIOAL ITAITLE                    | COMMON NAME                     | Live Stak  |  | % No.                                      |                                       |                          | noted.   |
| opulus balsamifera                    | balsam poplar                   | 0.5-0.75 m   |  | 25% 453                                    | 4                                     |                          | 2 Cail disturbance aball be minimized subana massible in all   |
| alix bebbiana                         | Bebb's willow                   | length.  | Plant at 1 per 1 sq.m. Follow all specifications   |  | 578/878                               |                          | Soil disturbance shall be minimized where possible in all riparian areas. Conduct close-cut clearing of shrubs instea          |
| alix exigua                           | narrowleaf willow               | Min 1.5  | and Guildelines.   | 25% 453                                    |                                       |                          | grubbing, where possible. The Contractor shall be responsi   |
| Cornus stolonifera                    | red-osier dogwood               | cm caliper   |  | 15% 272                                    | E 5                                   |                          | for installing additional plants per the prescribed planting n   |
| orrido ocoronigera                    | rea esier aegireea              | orr campor   |  | KES TOTAL 100% 1810                        | 7                                     | GENERAL                  | if necessary to restore any additional disturbed areas.  |
| Bed Type B: Tree & Shru               | ub (1 Par 3 ca m )              |  |  |  | \ \ \ \ \ \ \ \ \ \ \ \ \ \ \ \ \ \ \ |                          | 3 If invasive plant species are observed in the work area,   |
| BOTANICAL NAME                        |                                 | SIZE   | REMARKS  | В  | 7                                     |                          | machinery must avoid contact with the plant to prevent   |
| O TAINOAL ITAINL                      | COMMON NAME                     | Trees  | KEMAKKO  | % No.                                      | 7                                     |                          | spread. Species identification to be deferred to the QEP if  |
| icea mariana                          | black spruce                    | #1 Pot   |  | 20% 520                                    |                                       |                          | needed.  |
| icea manana<br>icea engelmannii       | Engelmann spruce                | #1 Pot   | -  | 5% 130                                     |                                       |                          | 4 All instream activities including riprap placement must be   |
|                                       | -                               | #1 Pot   | Plant at 1 per 3 sq.m. Maintain 1 m spacing from   | m retained 10% 260                         | DETAIL B. LIVE STAKE PLANTING:        |                          | conducted under QEP guidance.  |
| Populus balsamifera<br>Pinus contorta | balsam poplar<br>Lodgepole pine | #1 Pot   | trees. Follow all specifications in Details and G  | uidelines. 15% 390                         | GENERAL                               |                          | 5 Any disturbed soil surfaces in planting areas, including new topsoil installations, are to be finished "rough and loose" p   |
| Acer glabrum                          | Douglas maple                   | #1 Pot   |  | 5% 130                                     |                                       |                          | to planting, ie avoid both compaction and smooth grading.  |
| cer glubrum                           | Douglas maple                   | #11700   | TDE  | EES TOTAL 55% 650                          |                                       |                          |  |
|                                       |                                 | Shrubs & H   |  | LU TOTAL 0070 000                          | 1 1                                   |                          | 6 Apply a 300 mm layer of imported organic topsoil through   |
| ) a a a                               | neialde and                     |  | CI NO  | 100/ 700                                   |                                       | TOPSOIL & MULCH          | 7 Provide fertility and particle size analysis test for imported   |
| Rosa acicularis                       | prickly rose                    | #1 Pot   | Plant at 1 per 1 sq.m. Maintain 1 m distance fro   | om existing 10% 780                        | 5050/30E                              |                          | organic topsoil prior to starting work.  |
| Rubus parviflorus                     | thimbleberry                    | #1 Pot   | retained trees/shrubs. Follow all specifications in  | Details and 15% 1170                       | E 4                                   |                          | 8 After topsoil and shrub installations, planting area shall be  |
|                                       | highbush cranberry              | #1 Pot   | Guidelines.  | 5% 390                                     | 35.                                   |                          | finished with hydraulic application of prescribed seed with  |
| ymphoricarpus albus                   | snowberry                       | #1 Pot   | CUID!  | 15% 1170                                   | 0,1                                   |                          | mulch plus tackifier. Application rate to follow supplier  |
|                                       |                                 |  | SHRU   | JBS TOTAL 45% 3510                         | 4                                     |                          | recommendation.  |
|                                       |                                 |  |  |  | 1                                     |                          | 9 Live stakes must be kept moist, using wetted towels or sim   |
| ed Type C: Live Stakes                |                                 | 0175   | DEMARKO  |  | 7)                                    |                          | during transport and storage including onsite prior to plant   |
| SO I ANICAL NAME                      | COMMON NAME                     |  | REMARKS  | В  |                                       |                          | Store live stakes in a cool, moist, dark environment for no  |
|                                       | 1                               | Live Stak  |  | % No.                                      |                                       |                          | longer than 1 week, if necessary.  |
| Populus balsamifera                   | balsam poplar                   | 1.0-1.5 m  | Plant at 1 per 2 m linear distance in two rows sp  | paced 1 m 25% 1670                         | DETAIL C. LIVE STAKE PLANTING:        |                          | 10 Installation: use rebar to pilot a planting hole, then insert t   |
| Salix bebbiana                        | Bebb's willow                   | length.  | vertical distance apart. Plant using 2 stakes per h  | nole Follow 35% 2338                       | RIPRAP                                |                          | live stake. Stake must be approximately 75% length below   |
| Salix exigua                          | narrowleaf willow               | Min 2.0  | all specifications in Details and Guildeline   | 25% 1670                                   |                                       |                          | topsoil surface, with minimum 2 live buds above the surface  |
| Cornus stolonifera                    | red-osier dogwood               | cm caliper   | ·  | 15% 1002                                   |                                       | LIVE STAKING             | Lightly pack the topsoil around top of live stake to ensure s  |
|                                       |                                 |  | LIVE STAK  | KES TOTAL 100% 6680                        |                                       |                          | contact and stability.   |
|                                       | Sacruso 2.                      | War war  |  |  |                                       |                          | 11 Live stakes to be installed at approximately 1 per square   |
|                                       |                                 | THE STATE OF THE S |  |  |                                       |                          | metre.   |
|                                       |                                 | NY DAG   |  |  |                                       |                          | 12 Ensure all live stakes are installed with bottom/larger end   |
|                                       | THE WARRY TO                    |  |  |  | 1.00m                                 |                          | buried and buds pointing upward.   |
|                                       | 225 V6NV                        | 111111111111111111111111111111111111111  | Q  | 200 WATER SURFACE ELEVATION (SEE SECTIONS) | EXISTING GROUND                       |                          | 13 Live stakes for riparian planting areas shall be between 0.5  |
|                                       | 32081                           |  | COMPACTED TOPSOIL BERM (OR EQUIVALENT) TO HOLD IN WATER, USE   |  |                                       |                          | 0.75 m length. Minimum 1.5 cm caliper at large end.  |
| BREAK APA<br>OR GI                    | IRT ANY BOUND IRDLING ROOTS     | 10 ·   | TAMPER AND COMPACT IN LIFTS TO<br>ENSURE NO WATER SEEPS THROUGH.   |  |                                       |                          | 14 Live stakes for instream/riprap shall be between 1.0 to 1.5   |
|                                       | \ \\\\                          | Y/ /   | BLEND TO ADJACENT TREATMENTS- SOIL SURFACE TO BE LEFT LOOSE AND  |  |                                       |                          | length. Minimum 2.0 cm caliper at large end.   |
|                                       |                                 |  | LUMPY Q  | 2 ELEVATION (APPROXIMATE)                  | 1                                     |                          | 15 Apply topsoil to pockets and open spaces in the riprap live staking areas. Fill pockets with topsoil until flush with ripra |
|                                       |                                 | BARE IIII  | SPREAD ROOTS EVENLY THROUGHOUT TOPSOIL PRUNE ALL DAMAGED ROOTS   |  | 1.5                                   | LIVE STAKING IN RIPRAP   | slope face, then insert live stake into planting hole piloted  |
|                                       | POTTED                          | ROOT   |  |  |                                       | 2102 STAKING IN KII IVAI | rebar pole (or similar tool).  |
|                                       | ROOT                            |  | <del>-</del>   |  | LIVE STAKES IN TWO ROWS, INSTALL PER  |                          | 16 Live stakes to be installed in 2 rows spaced 1 metre vertical   |
|                                       |                                 |  | 300mm MIN. DEPTH LIGHTLY   | 1  | DETAIL C AND<br>GUIDELINES            |                          | at approximately 1 live stake per 2 metre linear distance a  |
|                                       |                                 |  | COMPACTED TOPSOIL, COMPACT IN LIFTS USING BOOT, ENSURING NO DAMAGE TO ROOTBALL   | 1  |                                       |                          | each row.  |
| COMPACTED SUE                         | BORADE -                        |  |  |  |                                       |                          | 17 Irrigation is required as needed during the growing season  |
| COMPACTED SOL                         | BORADE -                        |  | 150mm COMPACTED TOPSOIL. COMPACT<br>SOIL USING TAMPER  |  |                                       |                          | (May 1st through September 30th) to maintain survival of   |
|                                       | '                               |  |  |  |                                       |                          | planted stock. Water as frequently as necessary to mainta  |
|                                       |                                 |  |  |  |                                       | MAINTENANCE              | healthy plants.  |
|                                       | A 6118118 51 1115               | 10 011   | OLTEO  | )ETAII D   N/E                             | PEMENT IN OLASS AGGIZO DIDDAD         |                          | 18 Minimum 80% survival of planted stock is required. A 5-ye   |
|                                       | A. SHRUB PLANTIN                | NG ON LEVEL  | 01120  | DETAIL D. LIVE STAKE PLAC<br>ITS           | EMENT IN CLASS 100KG RIPRAP           |                          | maintenance and monitoring program must be conducted   |
| NTS                                   |                                 |  |  |  |                                       |                          | the planted area with QEP guidance.  |
|                                       |                                 | OR REPRODUCED W  | DESIGN IS THE PROPERTY OF McELHANNEY AND SHALL NOT BE USED, REUSED  ITHOUT THE CONSENT OF McELHANNEY. McELHANNEY WILL NOT BE HELD  THE IMPROPER OR UNAUTHORIZED USE OF THIS DRAWING AND DESIGN.  |  | McElhanney                            | REC                      | BIONAL DISTRICT OF FRASER-FORT GEORGE Drawing No.  |
|                                       |                                 | THIS DRAWING AND   | THE IMPROPER OR UNAUTHORIZED USE OF THIS DRAWING AND DESIGN.  DESIGN HAS BEEN PREPARED FOR THE CLIENT IDENTIFIED, TO MEET THE  EQUIREMENTS OF THE APPLICABLE PUBLIC AGENCIES AT THE TIME OF  |  | IVICEII IAI II IEY                    | OF APPLIED 8/0           | MCBRIDE BC   |
|                                       |                                 | PREPARATION. McE   | EQUIREMENTS OF THE APPLICABLE PUBLIC AGENCIES AT THE TIME OF LHANNEY, ITS EMPLOYEES, SUBCONSULTANTS AND AGENTS WILL NOT BE SSES OR OTHER CONSEQUENCES RESULTING FROM THE USE OR RELIANCE NGES MADE TO, THIS DRAWING, BY ANY THIRD PARTY, INCLUDING |  | Suite 12                              |                          | RE RIVER PROPOSED BANK ARMORING 401  |
|                                       |                                 |  | PPLIERS, CONSULTANTS AND STAKEHOLDERS, OR THEIR EMPLOYEES OR MCELHANNEY'S PRIOR WRITTEN CONSENT.   |  | 556 North Ne<br>Prince Georg          | ge BC                    | PROPOSED RIPARIAN RESTORATION  |
|                                       |                                 | McELHANNEY, ITS EI   | KISTING UNDERGROUND FACILITIES MAY NOT BE COMPLETE OR ACCURATE. MPLOYEES AND DIRECTORS ARE NOT RESPONSIBLE NOR LIABLE FOR THE  |  | Canada V2K<br>T 250 561 22            | TA1                      | Project Number   |
| 2024-03-04 ISSUED FOR TENDER          |                                 | JP GB LOCATION OF ANY U  | INDERGROUND CONDUITS, PIPES, CABLES OR OTHER FACILITIES WHETHER  |  | 1 200 301 22                          | 229                      | <b>DETAIL</b> 2341-21107-01  |

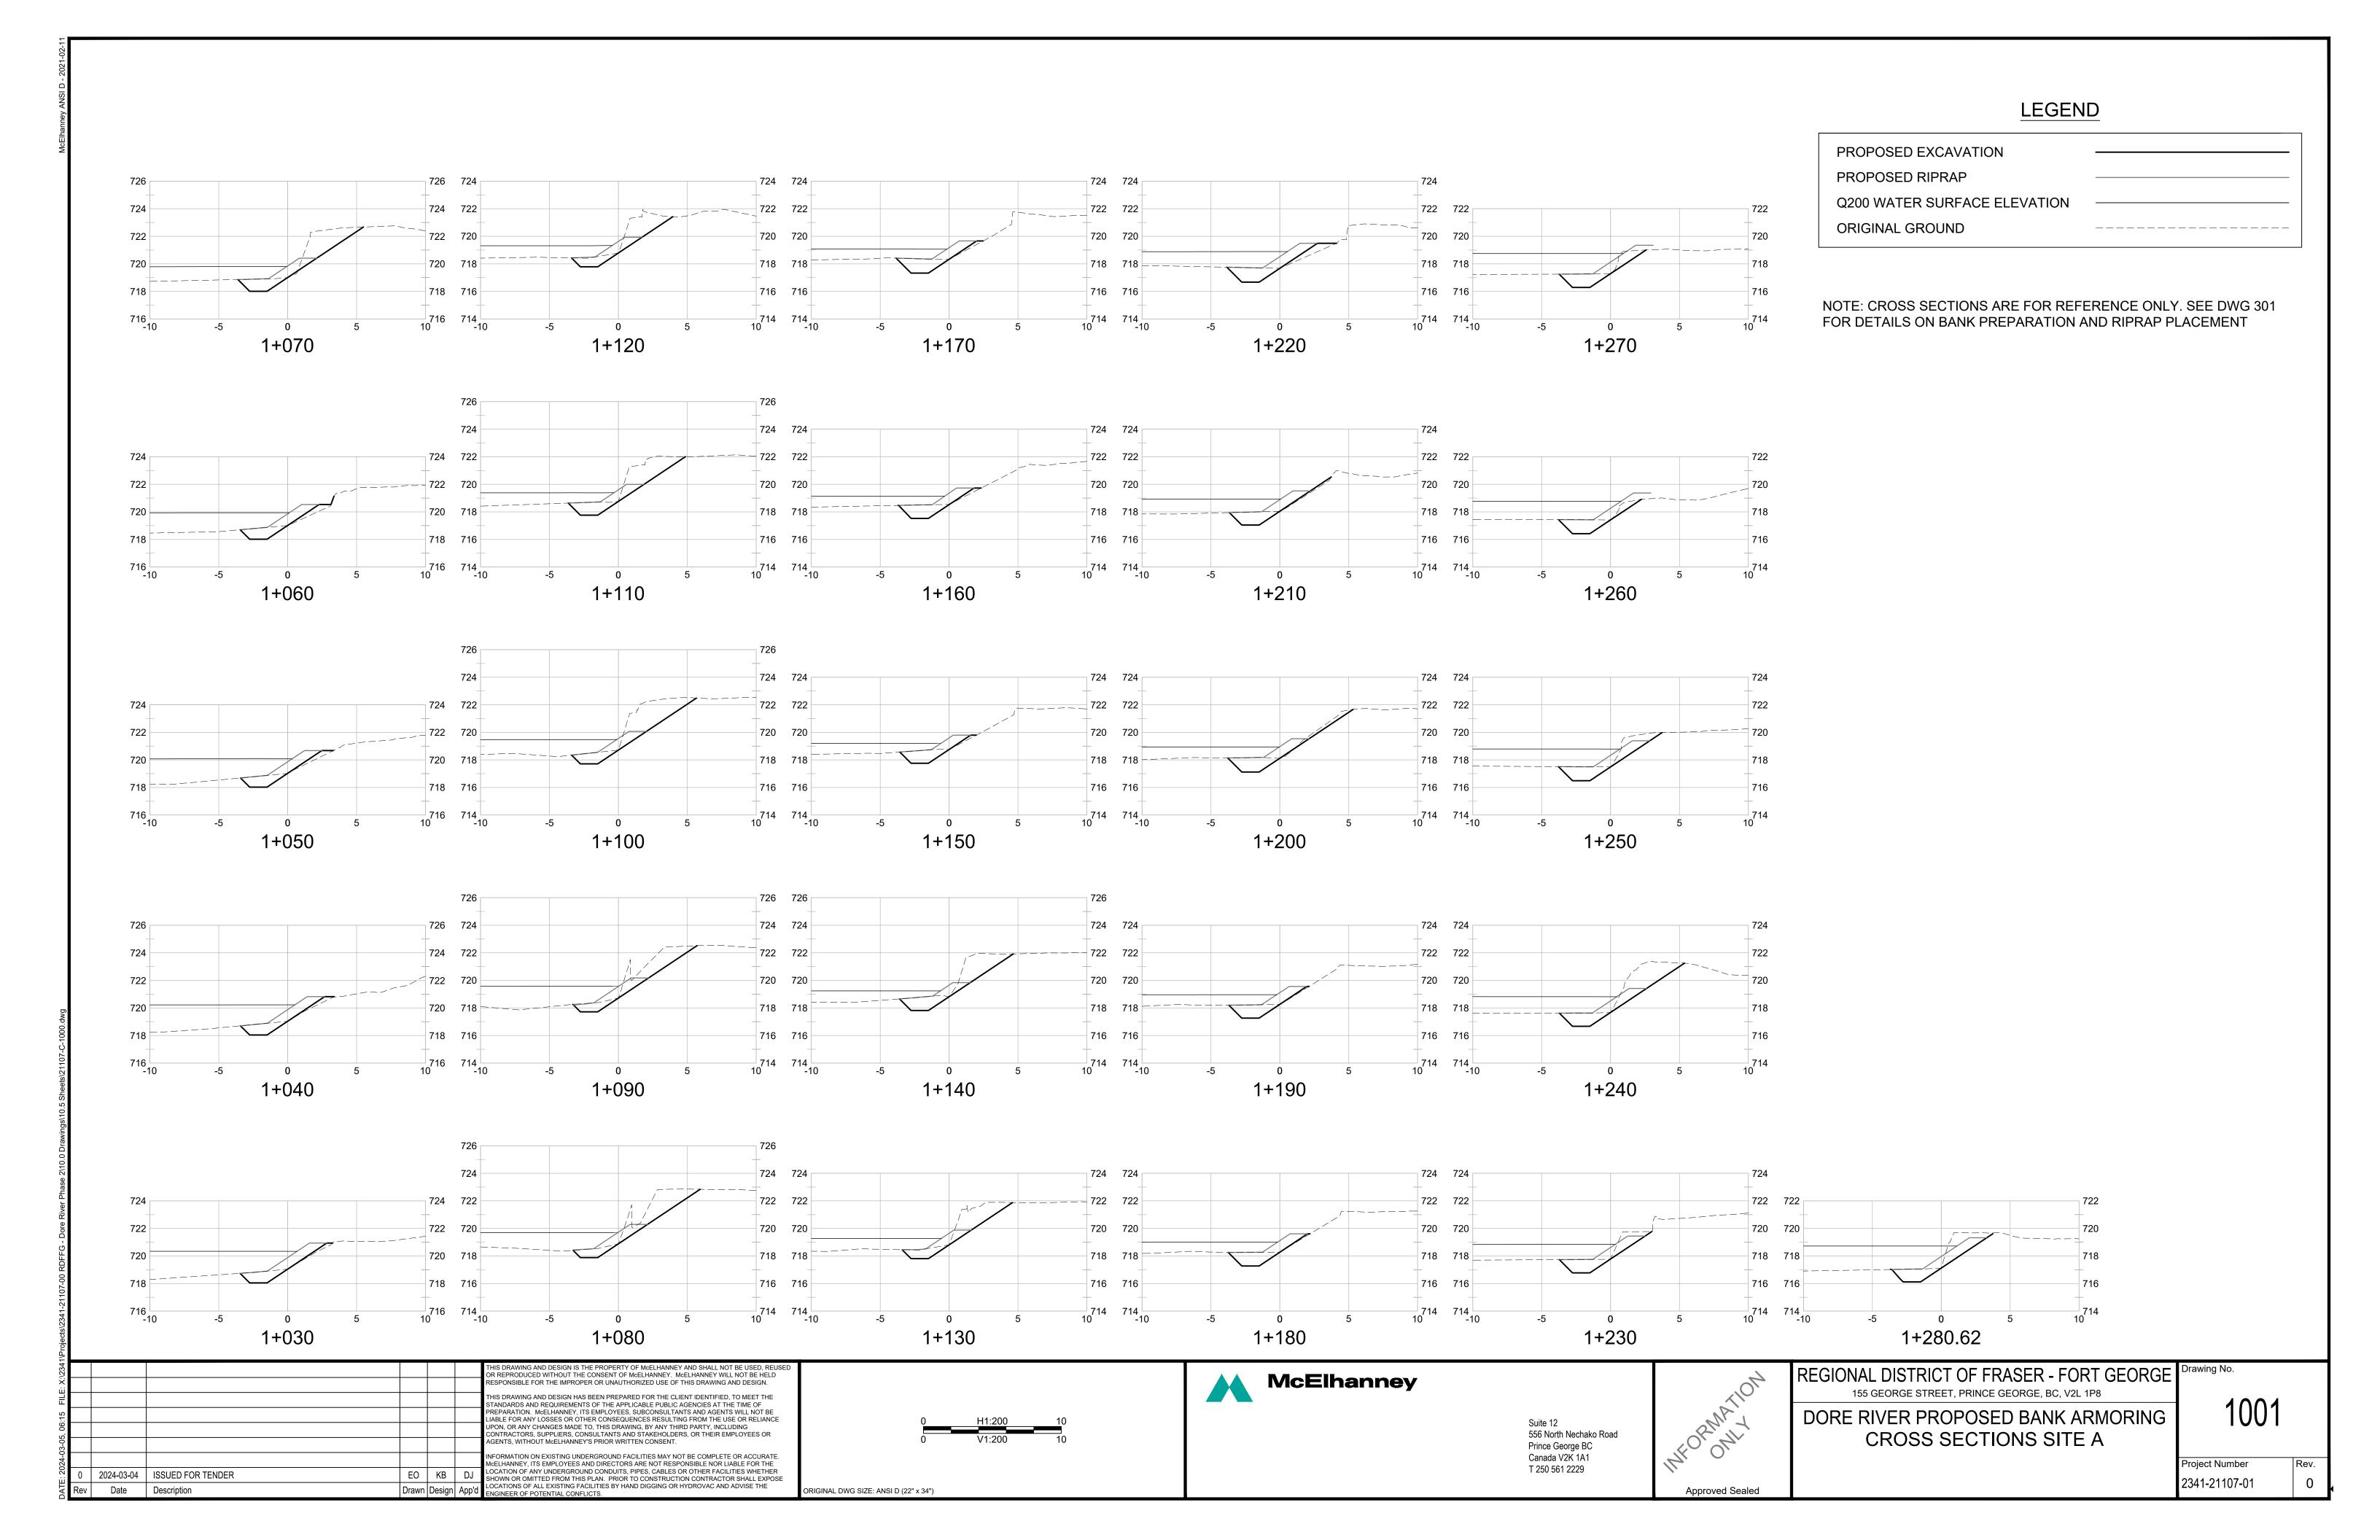

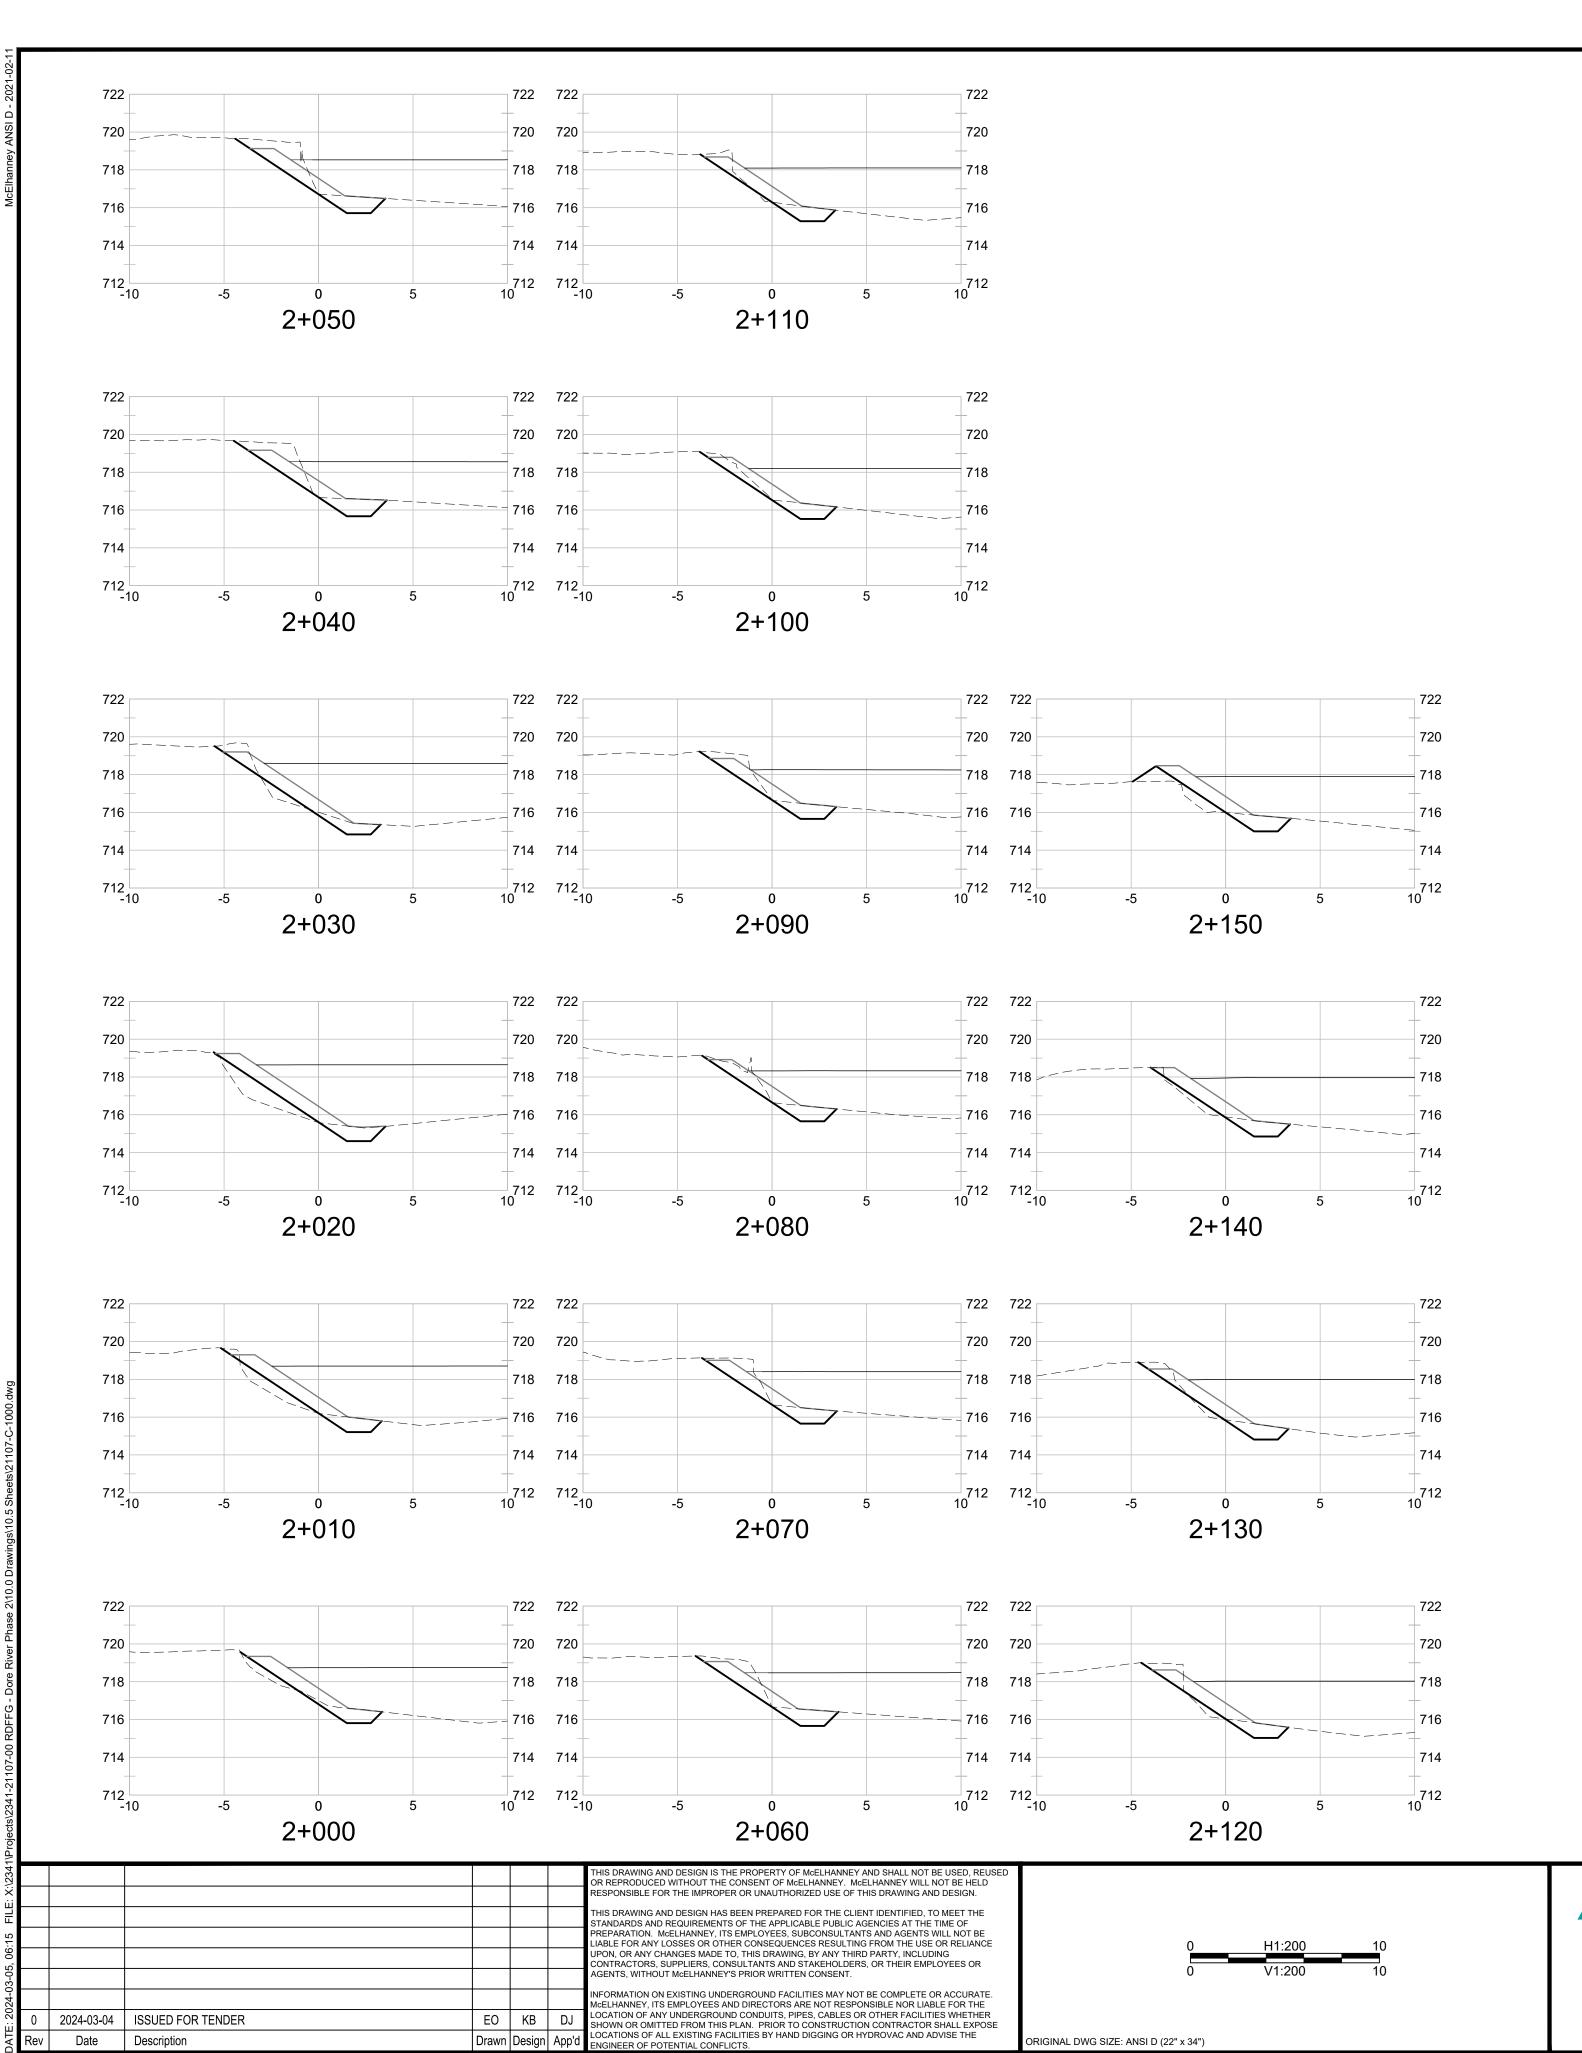

Date Description

# LEGEND

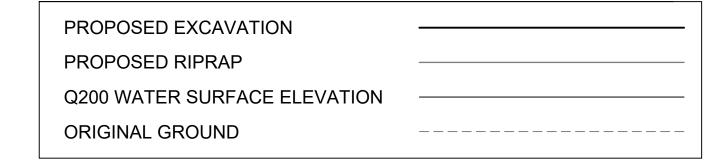

NOTE: CROSS SECTIONS ARE FOR REFERENCE ONLY. SEE DWG 301 FOR DETAILS ON BANK PREPARATION AND RIPRAP PLACEMENT

**McElhanney** 

Suite 12

556 North Nechako Road

Prince George BC Canada V2K 1A1

T 250 561 2229

REGIONAL DISTRICT OF FRASER - FORT GEORGE Drawing No. 155 GEORGE STREET, PRINCE GEORGE, BC, V2L 1P8

DORE RIVER PROPOSED BANK ARMORING

CROSS SECTIONS SITE B

1002

Project Number 2341-21107-01



Rev Date

Description

# LEGEND

| PROPOSED EXCAVATION          |  |
|------------------------------|--|
| PROPOSED RIPRAP              |  |
| Q200 WATER SURFACE ELEVATION |  |
| ORIGINAL GROUND              |  |
|                              |  |

NOTE: CROSS SECTIONS ARE FOR REFERENCE ONLY. SEE DWG 301 FOR DETAILS ON BANK PREPARATION AND RIPRAP PLACEMENT

REGIONAL DISTRICT OF FRASER - FORT GEORGE Drawing No. 155 GEORGE STREET, PRINCE GEORGE, BC, V2L 1P8

DORE RIVER PROPOSED BANK ARMORING CROSS SECTIONS SITE C

1003

Project Number 2341-21107-01

# LEGEND PROPOSED EXCAVATION PROPOSED RIPRAP Q200 WATER SURFACE ELEVATION ORIGINAL GROUND NOTE: CROSS SECTIONS ARE FOR REFERENCE ONLY. SEE DWG 301 722 722 722 FOR DETAILS ON BANK PREPARATION AND RIPRAP PLACEMENT 720 720 = 720 718 718 718 716 716 714 714 714 714 712 712 712 710 -10 710 710 10 -15 4+030 4+070 720 720 718 718 716 714 714 712 712 712 710 -10 710 -10 710 -10 \_\_\_710 10 4+020 4+060 4+100 720 — 718 718 716 714 712 712 712 710 -10 710 -10 4+050 4+090 4+012 724 722 720 720 718 718 716 718 716 714 712 712 712 4+000 4+040 4+080 THIS DRAWING AND DESIGN IS THE PROPERTY OF McELHANNEY AND SHALL NOT BE USED, REUS OR REPRODUCED WITHOUT THE CONSENT OF McELHANNEY. McELHANNEY WILL NOT BE HELD REGIONAL DISTRICT OF FRASER - FORT GEORGE Drawing No. **McElhanney** ESPONSIBLE FOR THE IMPROPER OR UNAUTHORIZED USE OF THIS DRAWING AND DESIGN. 155 GEORGE STREET, PRINCE GEORGE, BC, V2L 1P8 HIS DRAWING AND DESIGN HAS BEEN PREPARED FOR THE CLIENT IDENTIFIED, TO MEET THE STANDARDS AND REQUIREMENTS OF THE APPLICABLE PUBLIC AGENCIES AT THE TIME OF PREPARATION. McELHANNEY, ITS EMPLOYEES, SUBCONSULTANTS AND AGENTS WILL NOT BE DORE RIVER PROPOSED BANK ARMORING LIABLE FOR ANY LOSSES OR OTHER CONSEQUENCES RESULTING FROM THE USE OR RELIANCE UPON, OR ANY CHANGES MADE TO, THIS DRAWING, BY ANY THIRD PARTY, INCLUDING CONTRACTORS, SUPPLIERS, CONSULTANTS AND STAKEHOLDERS, OR THEIR EMPLOYEES OR AGENTS, WITHOUT McELHANNEY'S PRIOR WRITTEN CONSENT. Suite 12 556 North Nechako Road CROSS SECTIONS SITE D Prince George BC INFORMATION ON EXISTING UNDERGROUND FACILITIES MAY NOT BE COMPLETE OR ACCURATE. Canada V2K 1A1 McELHANNEY, ITS EMPLOYEES AND DIRECTORS ARE NOT RESPONSIBLE NOR LIABLE FOR THE LOCATION OF ANY UNDERGROUND CONDUITS, PIPES, CABLES OR OTHER FACILITIES WHETHER T 250 561 2229 2024-03-04 ISSUED FOR TENDER SHOWN OR OMITTED FROM THIS PLAN. PRIOR TO CONSTRUCTION CONTRACTOR SHALL EXPOSE LOCATIONS OF ALL EXISTING FACILITIES BY HAND DIGGING OR HYDROVAC AND ADVISE THE ENGINEER OF POTENTIAL CONFLICTS. 2341-21107-01 Date Description

